
GENERAL NOTES

- 1. THESE DRAWINGS ARE ISSUED TO INDICATE THE GENERAL SCOPE OF THE PROJECT.
- 2. CONTRACTOR IS TO FURNISH ALL ITEMS REQUIRED FOR PROPER COMPLETION OF THE WORK WITHOUT ADJUSTMENT TO CONTRACT PRICE. COMPLETED WORK SHALL BE OF SOUND AND QUALITY CONSTRUCTION AND THE CONTRACTOR SHALL BE SOLELY RESPONSIBLE FOR THE INCLUSION OF ADEQUATE AMOUNTS TO COVER INSTALLATION
- 3. THE CONTRACTOR IS RESPONSIBLE FOR ALL TEMPORARY BRACING AND SHORING REQUIRED FOR COMPLETION OF THE WORK.
- I. THE CONTRACTOR IS RESPONSIBLE FOR THE MEANS AND METHODS EMPLOYED FOR THE COMPLETION OF THE PROJECT.
- THE CONTRACTOR SHALL OBTAIN ALL PERMITS NECESSARY FOR COMPLETION OF THE WORK.
- 6. THE CONTRACTOR SHALL ARRANGE ALL REQUIRED INSPECTIONS.
- 7. THE CONTRACTOR SHALL VERIFY THE LOCATION, DEPTH, AND SIZE OF EXISTING UTILITIES WHETHER SHOWN ON THE PLANS OR NOT BEFORE BEGINNING CONSTRUCTION.
- 8. THE INFORMATION SHOWN ON THESE DRAWINGS CONCERNING TYPE AND LOCATION OF UNDERGROUND AND OTHER UTILITIES IS NOT GUARANTEED TO BE ACCURATE OR ALL—INCLUSIVE. THE CONTRACTOR IS RESPONSIBLE FOR MAKING HIS OWN DETERMINATIONS AS TO THE TYPE AND LOCATION OF ALL UNDERGROUND AND OTHER UTILITIES AS MAY BE NECESSARY IN AVOIDING DAMAGE THERETO. AS REQUIRED BY "THE TEXAS UNDERGROUND FACILITY DAMAGE PREVENTION AND SAFETY ACT" TEXAS ONE CALL SYSTEM MUST BE CONTACTED AT LEAST 48 HOURS PRIOR TO ANY EXCAVATION OPERATIONS BEING PERFORMED. IT IS THE CONTRACTOR'S RESPONSIBILITY TO CONTACT TEXAS ONE CALL SYSTEM.
- 9. THE CONTRACTOR SHALL REPAIR ALL PORTIONS OF PAVEMENT DAMAGED BY HIS EQUIPMENT. AT CONTRACTOR'S EXPENSE.
- 10. ALL AREAS DISTURBED BY CONSTRUCTION SHALL BE RESTORED TO THEIR ORIGINAL OR BETTER CONDITION, UNLESS OTHERWISE NOTED.
- 11. ALL BACKFILL SHALL BE PLACED IN ACCORDANCE WITH THE TYPICAL TRENCH DETAIL SHOWN ON MISC. DETAIL SHEET.
- 12. EXISTING IMPROVEMENTS INCLUDING, BUT NOT LIMITED TO FENCES, DRIVEWAYS, SIDEWALKS, PAVEMENT, CURBS, UTILITY AND OIL OR GAS PIPELINES, DRAINAGE STRUCTURES WHICH ARE REMOVED OR ALTERED TO PERMIT INSTALLATION OF THE WORK SHALL BE REPAIRED OR REPLACED BY THE CONTRACTOR, AT THE CONTRACTOR'S EXPENSE, IN THE SAME LOCATION AND IN A CONDITION AS GOOD OR BETTER THAN FOUND.
- 13. CONTRACTOR SHALL TAKE SPECIAL PRECAUTIONS IN THE VICINITY OF ANY OVERHEAD ELECTRIC LINES. CONTRACTOR SHALL ABIDE BY NATIONAL ELECTRIC CODE AND ANY REQUIREMENT BY OWNER OF THE ELECTRIC LINE.
- 14. CONTRACTOR SHALL NOTIFY OWNER AND RECEIVE AUTHORIZATION FOR THE DATE AND TIME FOR WHICH THE PROPOSED UTILITIES WILL BE CONNECTED TO THE EXISTING UTILITIES.
- 15. CONTRACTOR SHALL MAINTAIN ONE SET OF "AS-BUILT" DRAWINGS SHOWING CLEARLY ALL FIELD CONDITIONS, WHETHER EXISTING OR PROPOSED, WHICH DIFFER FROM THE CONDITIONS SHOWN ON THESE DRAWINGS. THE LOCATION, SIZE AND TYPE OF ALL UTILITY AND PIPELINES ENCOUNTERED THROUGHOUT THE PROJECT SHALL BE SHOWN ON THE "AS-BUILT" DRAWINGS.
- 16. FOR UTILITY LINES UNDER PAVED AREAS, TRENCH SHALL BE BACKFILLED AND COMPACTED IN 8" LOOSE LIFTS WITH SELECT MATERIAL. NONPLASTIC MATERIAL SHALL BE CEMENT STABILIZED. COMPACTION OF CLAY MATERIAL SHALL BE BY HAND—HELD MECHANICAL TAMPER. ("WACKER—PACKER" OR EQUAL) TO 95% STANDARD PROCTOR DENSITY.
- 17. THE CONTRACTOR SHALL INSTALL AND MAINTAIN SILT FENCING AS REQUIRED BY TXDOT, TCEQ, & EPA.
- 18. THE CONTRACTOR SHALL BE RESPONSIBLE FOR OBTAINING ALL PERMITS REQUIRED TO COMPLETE THE WORK.
- 19. NO FIRES WILL BE ALLOWED UNLESS OTHERWISE NOTED.
- 20. ALL DRIVEWAYS THAT ARE DAMAGED AS A RESULT OF THE CONSTRUCTION SHALL BE REPAIRED TO A CONDITION EQUAL TO OR BETTER THAN THEIR CONDITION PRIOR TO THE CONSTRUCTION, USING LIKE MATERIALS. ALL CONCRETE DRIVEWAYS SHALL BE REPAIRED WITH CONCRETE, ALL OTHERS SHALL BE REPAIRED WITH ASPHALT.
- 21. ADDITIONAL UTILITY AND PIPELINES NOT SHOWN ON THE DRAWINGS MAY BE ENCOUNTERED THROUGHOUT THE PROJECT. EXACT LOCATIONS OF ALL EXISTING UNDERGROUND UTILITIES AND PIPELINES, WHETHER SHOWN ON THESE PLANS OR NOT, SHOULD BE DETERMINED IN THE FIELD PRIOR TO EXCAVATION.
- 22. NO REVISIONS SHALL BE MADE IN THESE PLANS WITHOUT THE APPROVAL OF THE DESIGN ENGINEER OR AN AUTHORIZED REPRESENTATIVE OF THE OWNER.
- 23. THE CONTRACTOR IS RESPONSIBLE FOR JOBSITE CONDITIONS AT ALL TIMES DURING CONSTRUCTION AND SHALL DEFEND, INDEMNIFY AND HOLD HARMLESS THE OWNER, HIS AGENTS AND THE ENGINEER AGAINST ANY CLAIMS RESULTING FROM SITE CONDITIONS DURING THE COURSE OF CONSTRUCTION. THE JOBSITE SHALL BE MAINTAINED IN A SAFE CONDITION DURING AND AFTER WORK HOURS IN ACCORDANCE WITH THE STANDARD SPECIFICATIONS FOR PUBLIC WORKS CONSTRUCTION.
- 24. CONTRACTOR SHALL PROVIDE AND MAINTAIN PROTECTIVE FENCING TO SECURE THE ENTIRE CONSTRUCTION SITE PRIOR TO DEMOLITION FOR THE DURATION OF THE PROJECT.

ENLARGED DEMOLITION PLAN (PHASE 1)

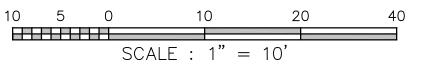

<u>CAUTION</u> <u>EXISTING UTILITIES</u>

EXISTING UTILITIES AND UNDERGROUND FACILITIES INDICATED ON THESE PLANS HAVE BEEN LOCATED FROM REFERENCED INFORMATION. IT IS THE RESPONSIBILITY OF THE CONTRACTOR TO VERIFY BOTH HORIZONTAL AND VERTICAL LOCATIONS OF ALL EXISTING UTILITIES AND UNDERGROUND FACILITIES PRIOR TO CONSTRUCTION AND TO TAKE NECESSARY PRECAUTIONS TO PROTECT ALL FACILITIES ENCOUNTERED. THE CONTRACTOR SHALL PRESERVE AND PROTECT ALL EXISTING UTILITIES FROM DAMAGE DURING CONSTRUCTION.

E N G - N E R R P.O. BOX 983 TX FIRM # 903.413.8897

PURPOSES.
ISSUED BY
ALLEN M. TAYLOR, P.E.
LICENSE # 131295

2021 FRUITVALE ISD
ADMINISTRATION BLDG
FRUITVALE, TEXAS 75127





Issue/Revision Date & Description
IFB: 7-1-21

Job Number: 050-21003


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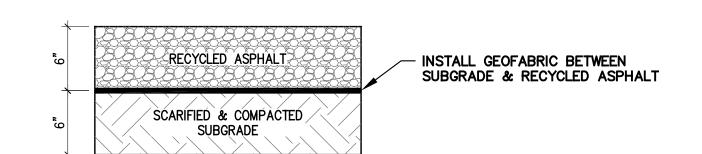
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TEMPORARY TURN AROUND (PHASE 1)



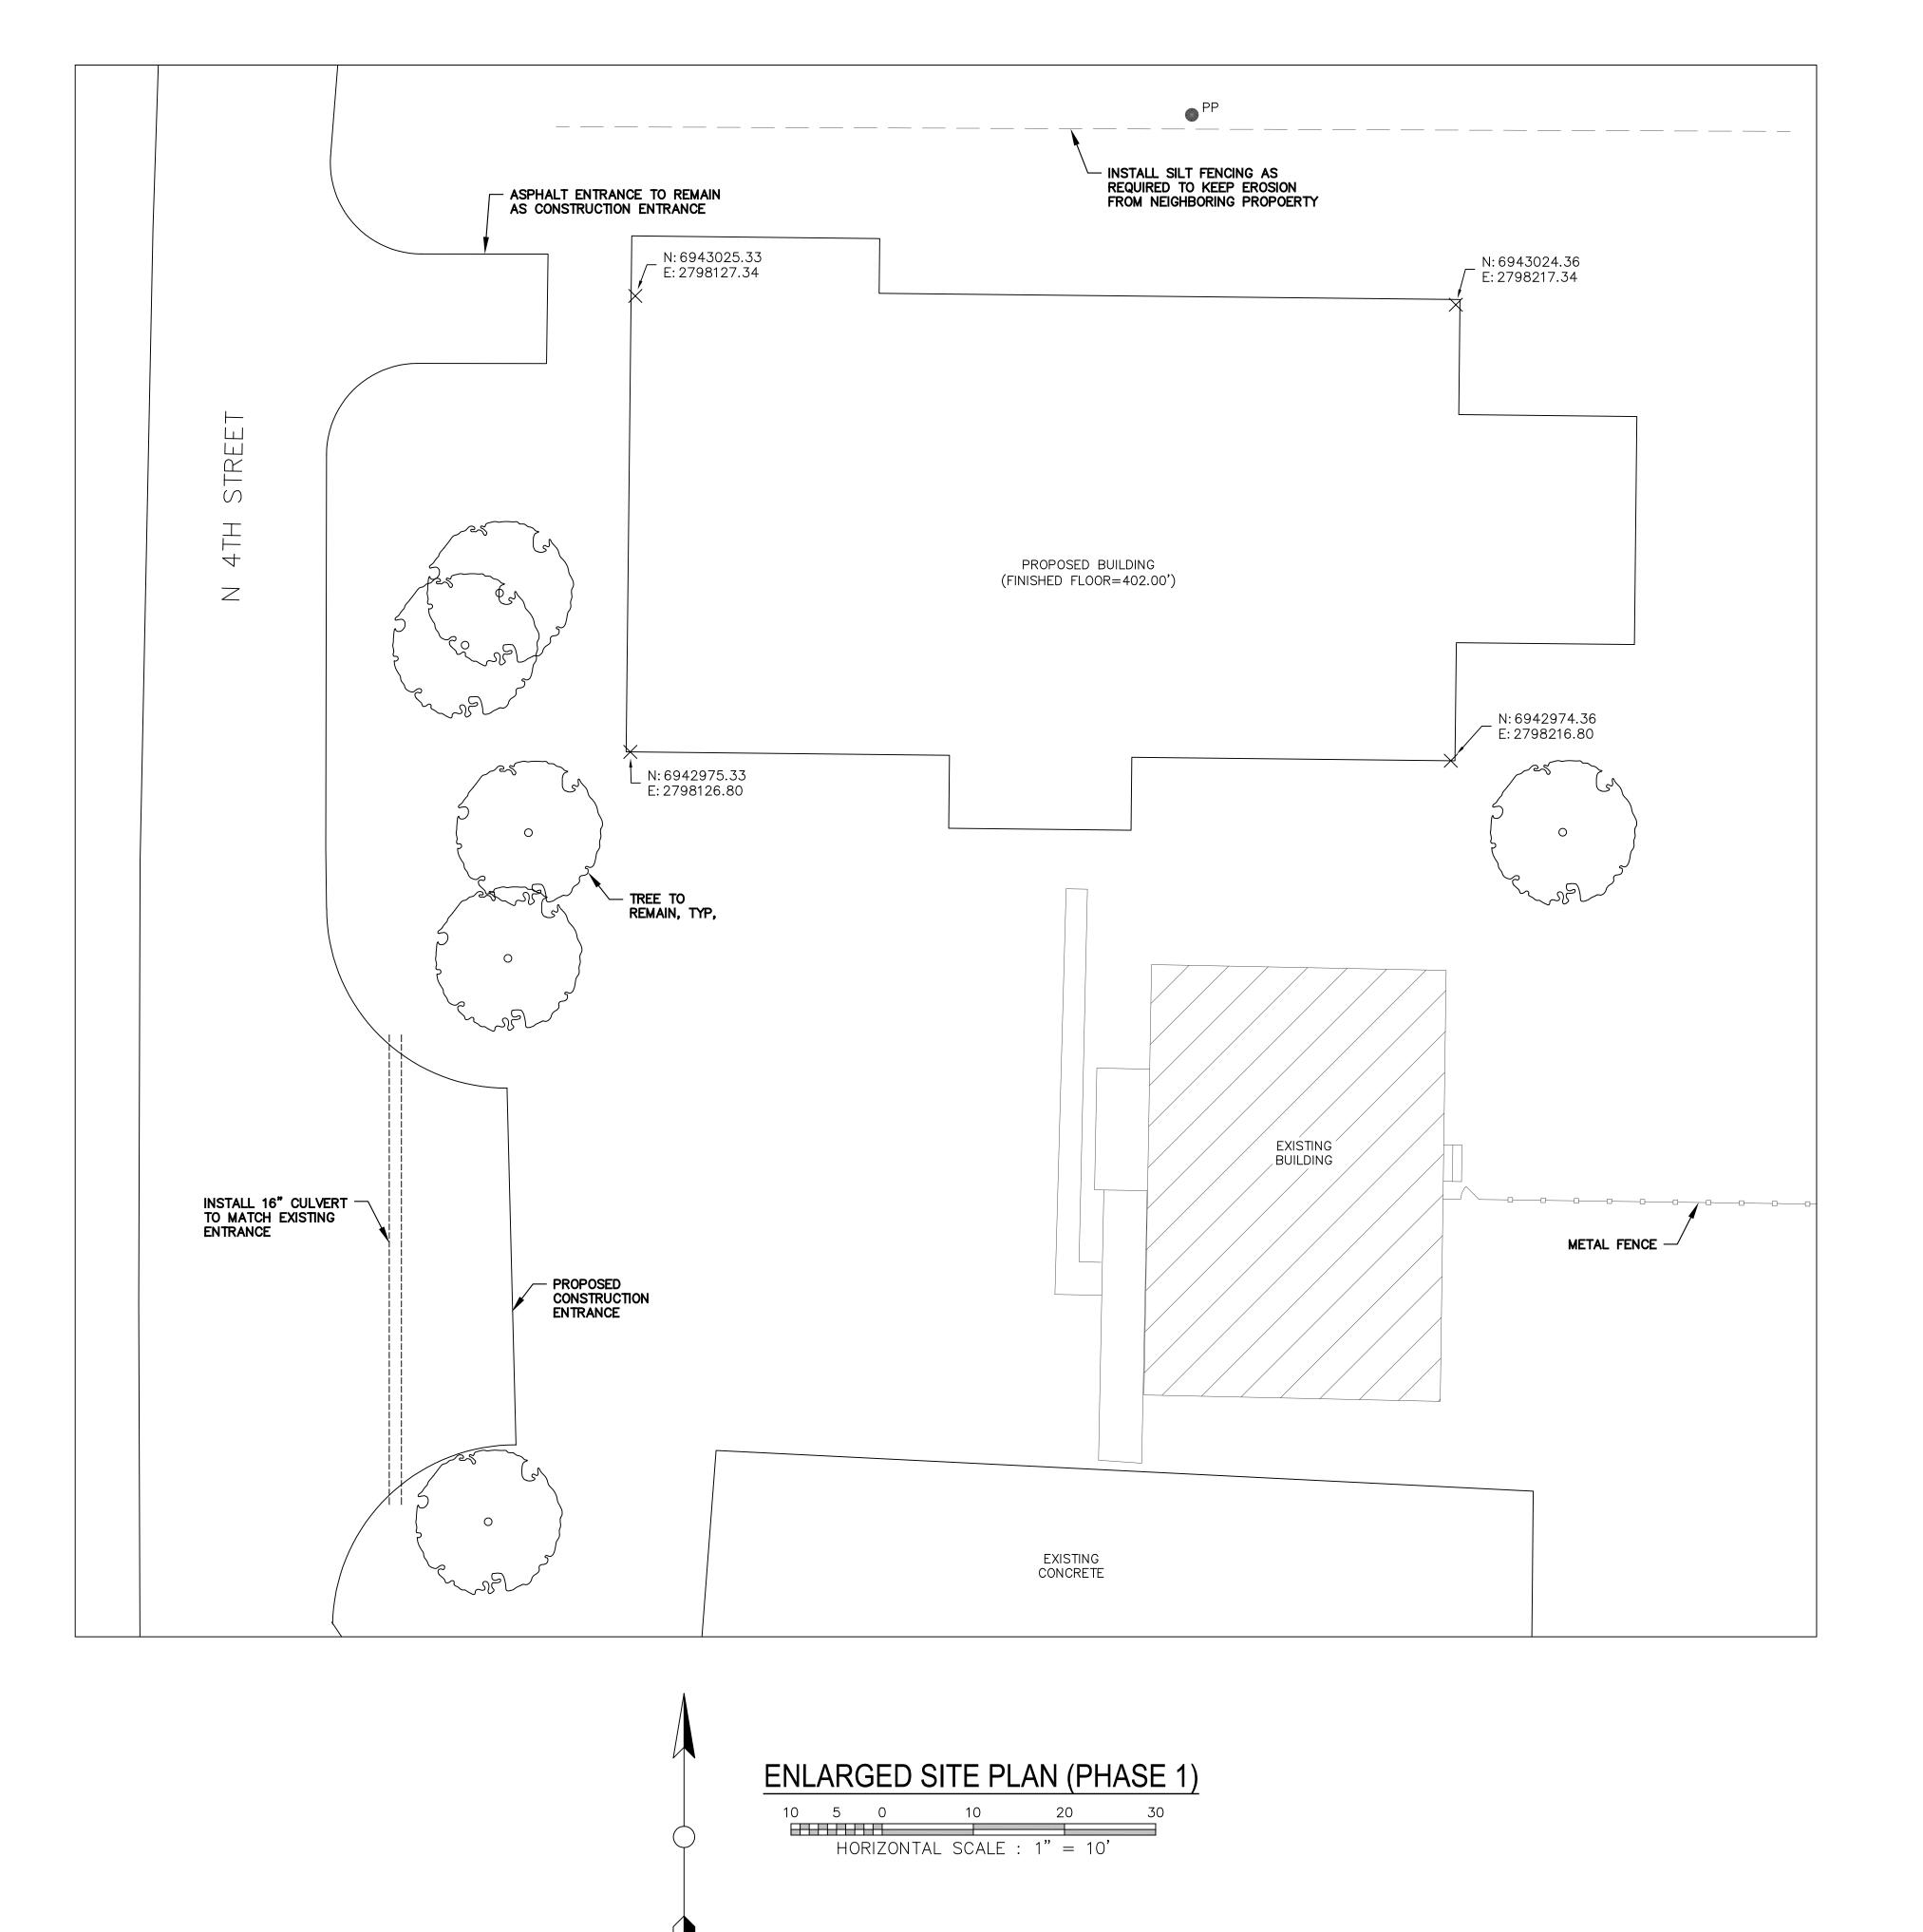


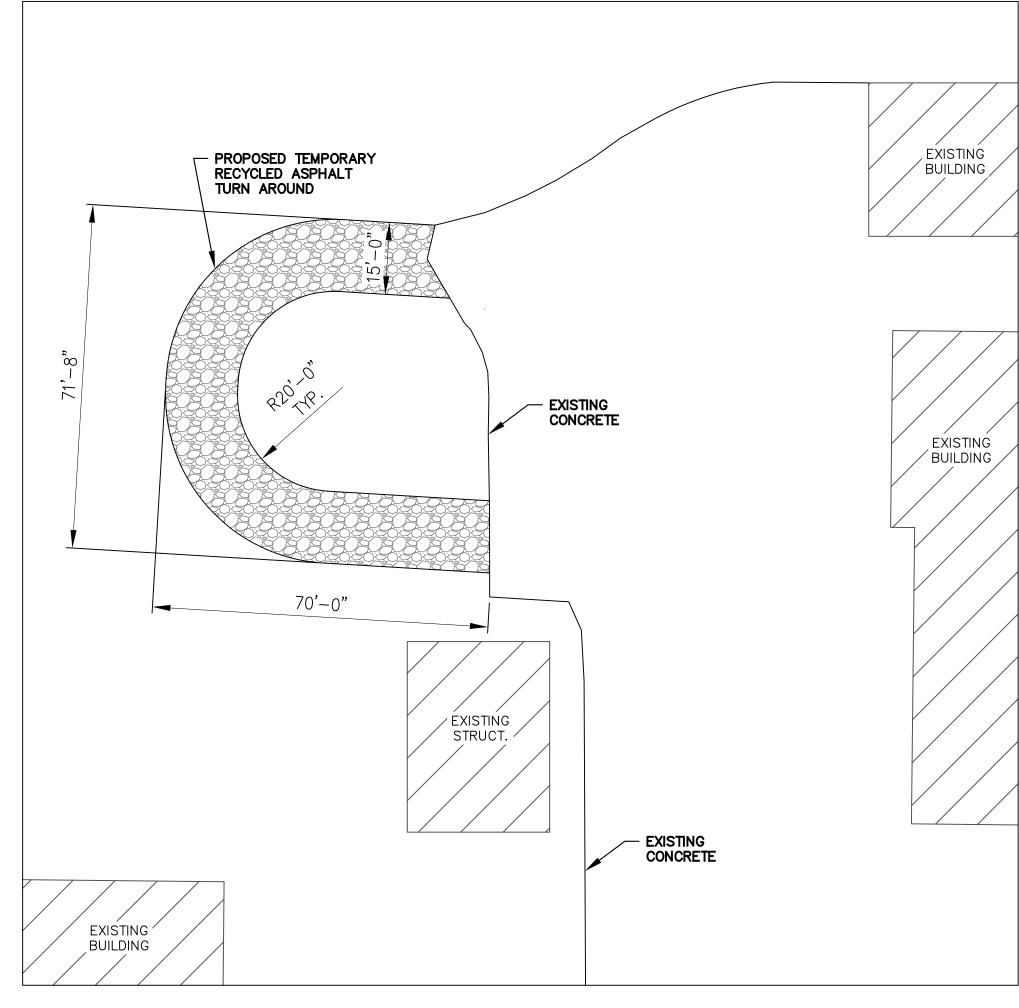TYPICAL SECTION AT TEMPORARY TURN AROUND

Scale: NTS

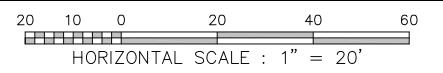


Job Number: 050-21003

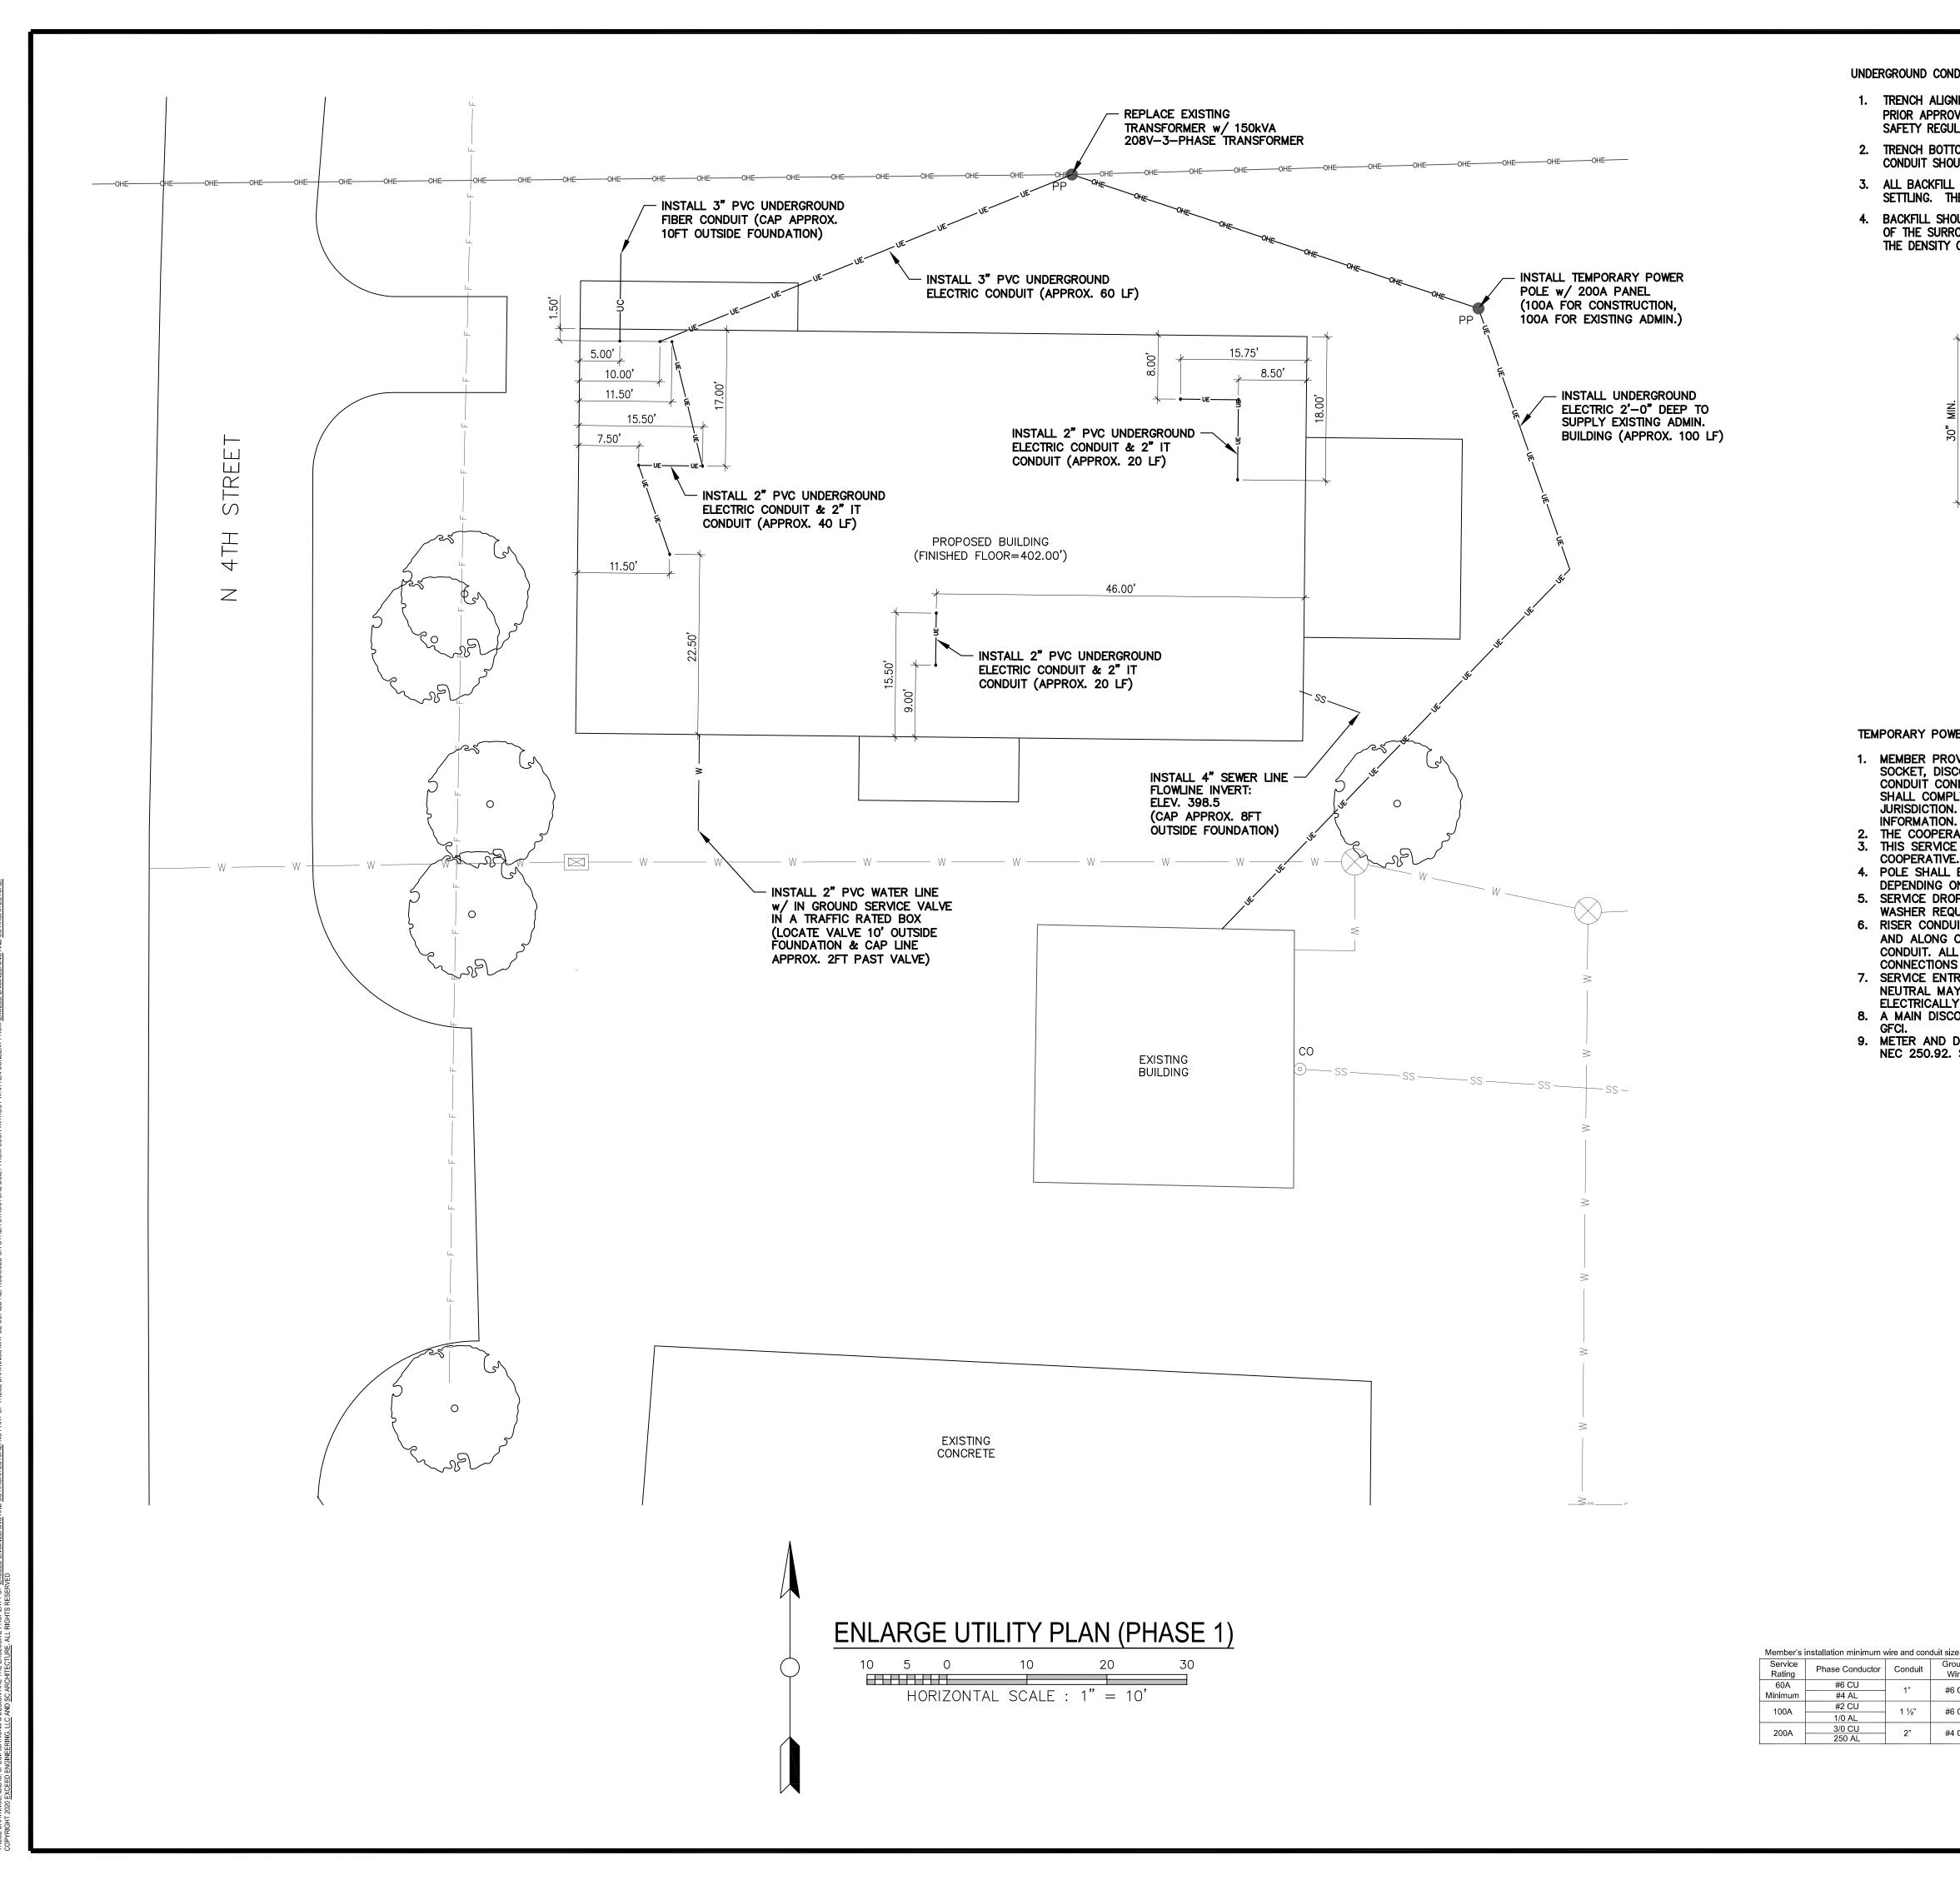

UNDERGROUND CONDUIT NOTES:

- 1. TRENCH ALIGNMENT SHALL BE AS STRAIGHT AS CONDITIONS PERMIT. ANY DEVIATIONS FROM PLANNED ALIGNMENT SHALL HAVE PRIOR APPROVAL BY THE PROJECT ENGINEER/INSPECTOR. ALL TRENCH CUTS SHALL BE IN ACCORDANCE WITH EXISTING SAFETY REGULATION IN EFFECT.
- 2. TRENCH BOTTOM SHOULD BE UNDISTURBED, TAMPED, OR RELATIVELY SMOOTH EARTH. WHERE EXCAVATION IS IN ROCK, THE CONDUIT SHOULD BE LAID ON A LAYER OF CLEAN BACKFILL.
- 3. ALL BACKFILL SHOULD BE FREE OF DEBRIS OR OTHER MATERIAL THAT MAY DAMAGE THE CONDUIT SYSTEM OR CAUSE SETTLING. THE MATERIAL SHOULD FILL THE VOIDS AROUND THE CONDUIT TO PREVENT HOT SPOTS & SETTLING.
- 4. BACKFILL SHOULD BE ADEQUATELY COMPACTED. BACKFILL NOT UNDER PAVEMENT SHOULD BE COMPACTED TO THE DENSITY OF THE SURROUNDING UNDISTURBED SOIL. BACKFILL UNDER PAVEMENT SHOULD BE COMPACTED TO NOT LESS THAN 95% OF THE DENSITY OF UNDISTURBED SOIL AS DETERMINED BY ASTM D-698.

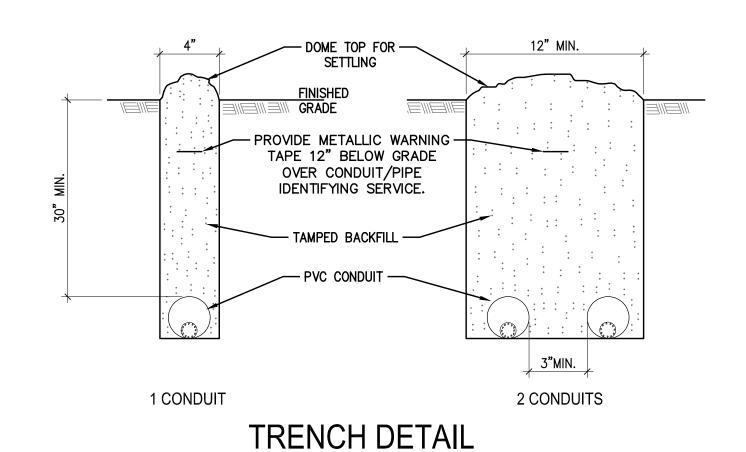


TEMPORARY POWER POLE NOTES:

#6 CU

#4 CU

1/0 AL 3/0 CU 250 AL 2"

- 1. MEMBER PROVIDES AND INSTALLS: POLE, BRACING, SERVICE DROP ATTACHMENT, CONDUITS, WEATHERHEAD, METER SOCKET, DISCONNECT SWITCH, GROUND ROD AND WIRE, AND ALL RELATED MATERIALS. ALL EQUIPMENT AND CONDUIT CONNECTIONS SHALL BE RAINTIGHT. ANY RECEPTACLES SHALL BE WEATHERPROOF AND GFCI. ALL WORK SHALL COMPLY WITH COOPERATIVE STANDARDS, THE NATIONAL ELECTRICAL CODE AND AUTHORITIES HAVING JURISDICTION. REFER TO THE FECC MEMBER INSTALLATION STANDARDS FOR ELECTRIC SERVICE FOR MORE
- THE COOPERATIVE PROVIDES THE METER AND SERVICE DROP AND MAKES CONNECTIONS AT THE WEATHERHEAD. THIS SERVICE SHALL BE INSTALLED AT A LOCATION MUTUALLY AGREED UPON BY THE MEMBER AND THE COOPERATIVE. THE LOCATION SHOULD BE LOCATED AWAY FROM TRAFFIC AREAS TO AVOID DAMAGE.
- 4. POLE SHALL BE MIN. 6" ROUND OR 6"x6" TREATED WOOD. POLE LENGTH SHALL BE MIN. 17'-0" OR 21'-0"
- DEPENDING ON WEATHERHEAD HEIGHT REQUIREMENT.
- 5. SERVICE DROP ATTACHMENT POINT: MEMBER INSTALLED 1/2" GALVANIZED STEEL EYEBOLT AND 2"x2" SQUARE 6. RISER CONDUIT SHALL BE SIZED PER TABLE. INSTALL CONDUIT STRAPS WITHIN 12" OF WEATHERHEAD AND METER.
- AND ALONG CONDUIT WITH A MAX. 3'-0" SPACING FOR CONDUIT 1" OR LESS OR 5'-0" SPACING FOR LARGER CONDUIT. ALL CONDUITS TO BE ELECTRICAL GRADE EMT, IMC, RMC OR SCHEDULE 80 PVC. ALL CONDUIT CONNECTIONS TO BE RAINTIGHT.
- 7. SERVICE ENTRANCE CONDUCTORS SHALL BE SIZED PER TABLE BELOW AND EXTEND 36" OUT OF WEATHERHEAD. NEUTRAL MAY BE BARE OR SHALL BE INSULATED AND MARKED WITH WHITE TAPE. WHEN AIR CONDITIONED OR
- ELECTRICALLY HEATED CONSTRUCTION TRAILERS ARE TO BE SERVED, MIN. 100A RATED SERVICE IS REQUIRED. 8. A MAIN DISCONNECT IS REQUIRED FOR 7 OR MORE BREAKERS. ALL RECEPTACLES SHALL BE WEATHERPROOF AND
- 9. METER AND DISCONNECT ENCLOSURES MUST BE GROUNDED AND BONDED TOGETHER USING SPECIAL MEANS PER NEC 250.92. STANDARD LOCKNUTS OR BUSHINGS ARE NOT ACCEPTABLE.

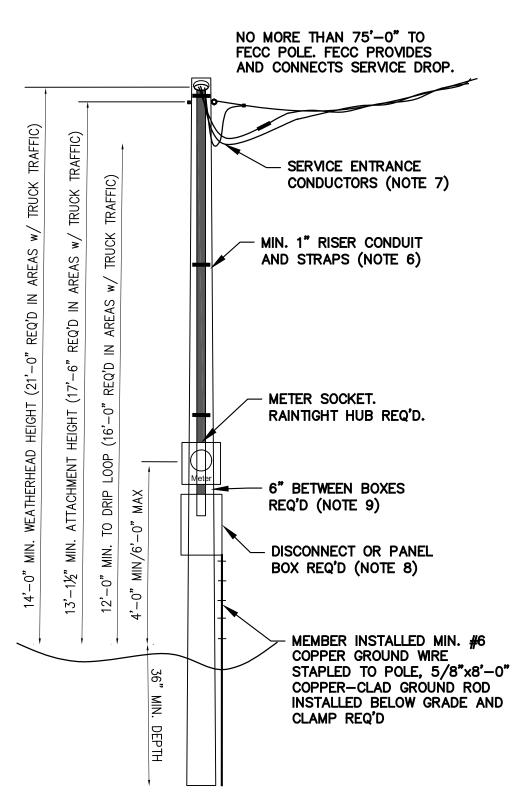


TEMPORARY POWER POLE DETAIL

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Job Number: 050-21003



Point #	Elevation	Northing	Easting	Description				
1	400.76	6943034.53	2798093.37	Benchmark #1				
2	400.17	6943027.77	2798251.22	Benchmark #2				
3	401.88	6943025.92	2798126.89	Building Corne				
4	401.88	6943024.36	2798217.34	Building Corne				
5	401.88	6942974.36	2798216.80	Building Corne				
6	401.88	6942975.33	2798126.80	Building Corne				
7	401.82	6943031.92	2798126.95	Top of Paving				
8	401.88	6943025.63	2798154.10	Top of Paving				
9	401.82	6943031.63	2798154.16	Top of Paving				
10	401.88	6943012.32	2798217.66	Top of Paving				
11	401.88	6942987.32	2798217.39	Top of Paving				
12	401.68	6943012.11	2798237.20	Top of Paving				
13	401.68	6942987.11	2798236.94	Top of Paving				
14	401.88	6942974.74	2798181.80	Top of Paving				
15	401.88	6942974.96	2798161.80	Top of Paving				
16	401.80	6942966.96	2798161.71	Top of Paving				
17	401.80	6942966.74	2798181.71	Top of Paving				

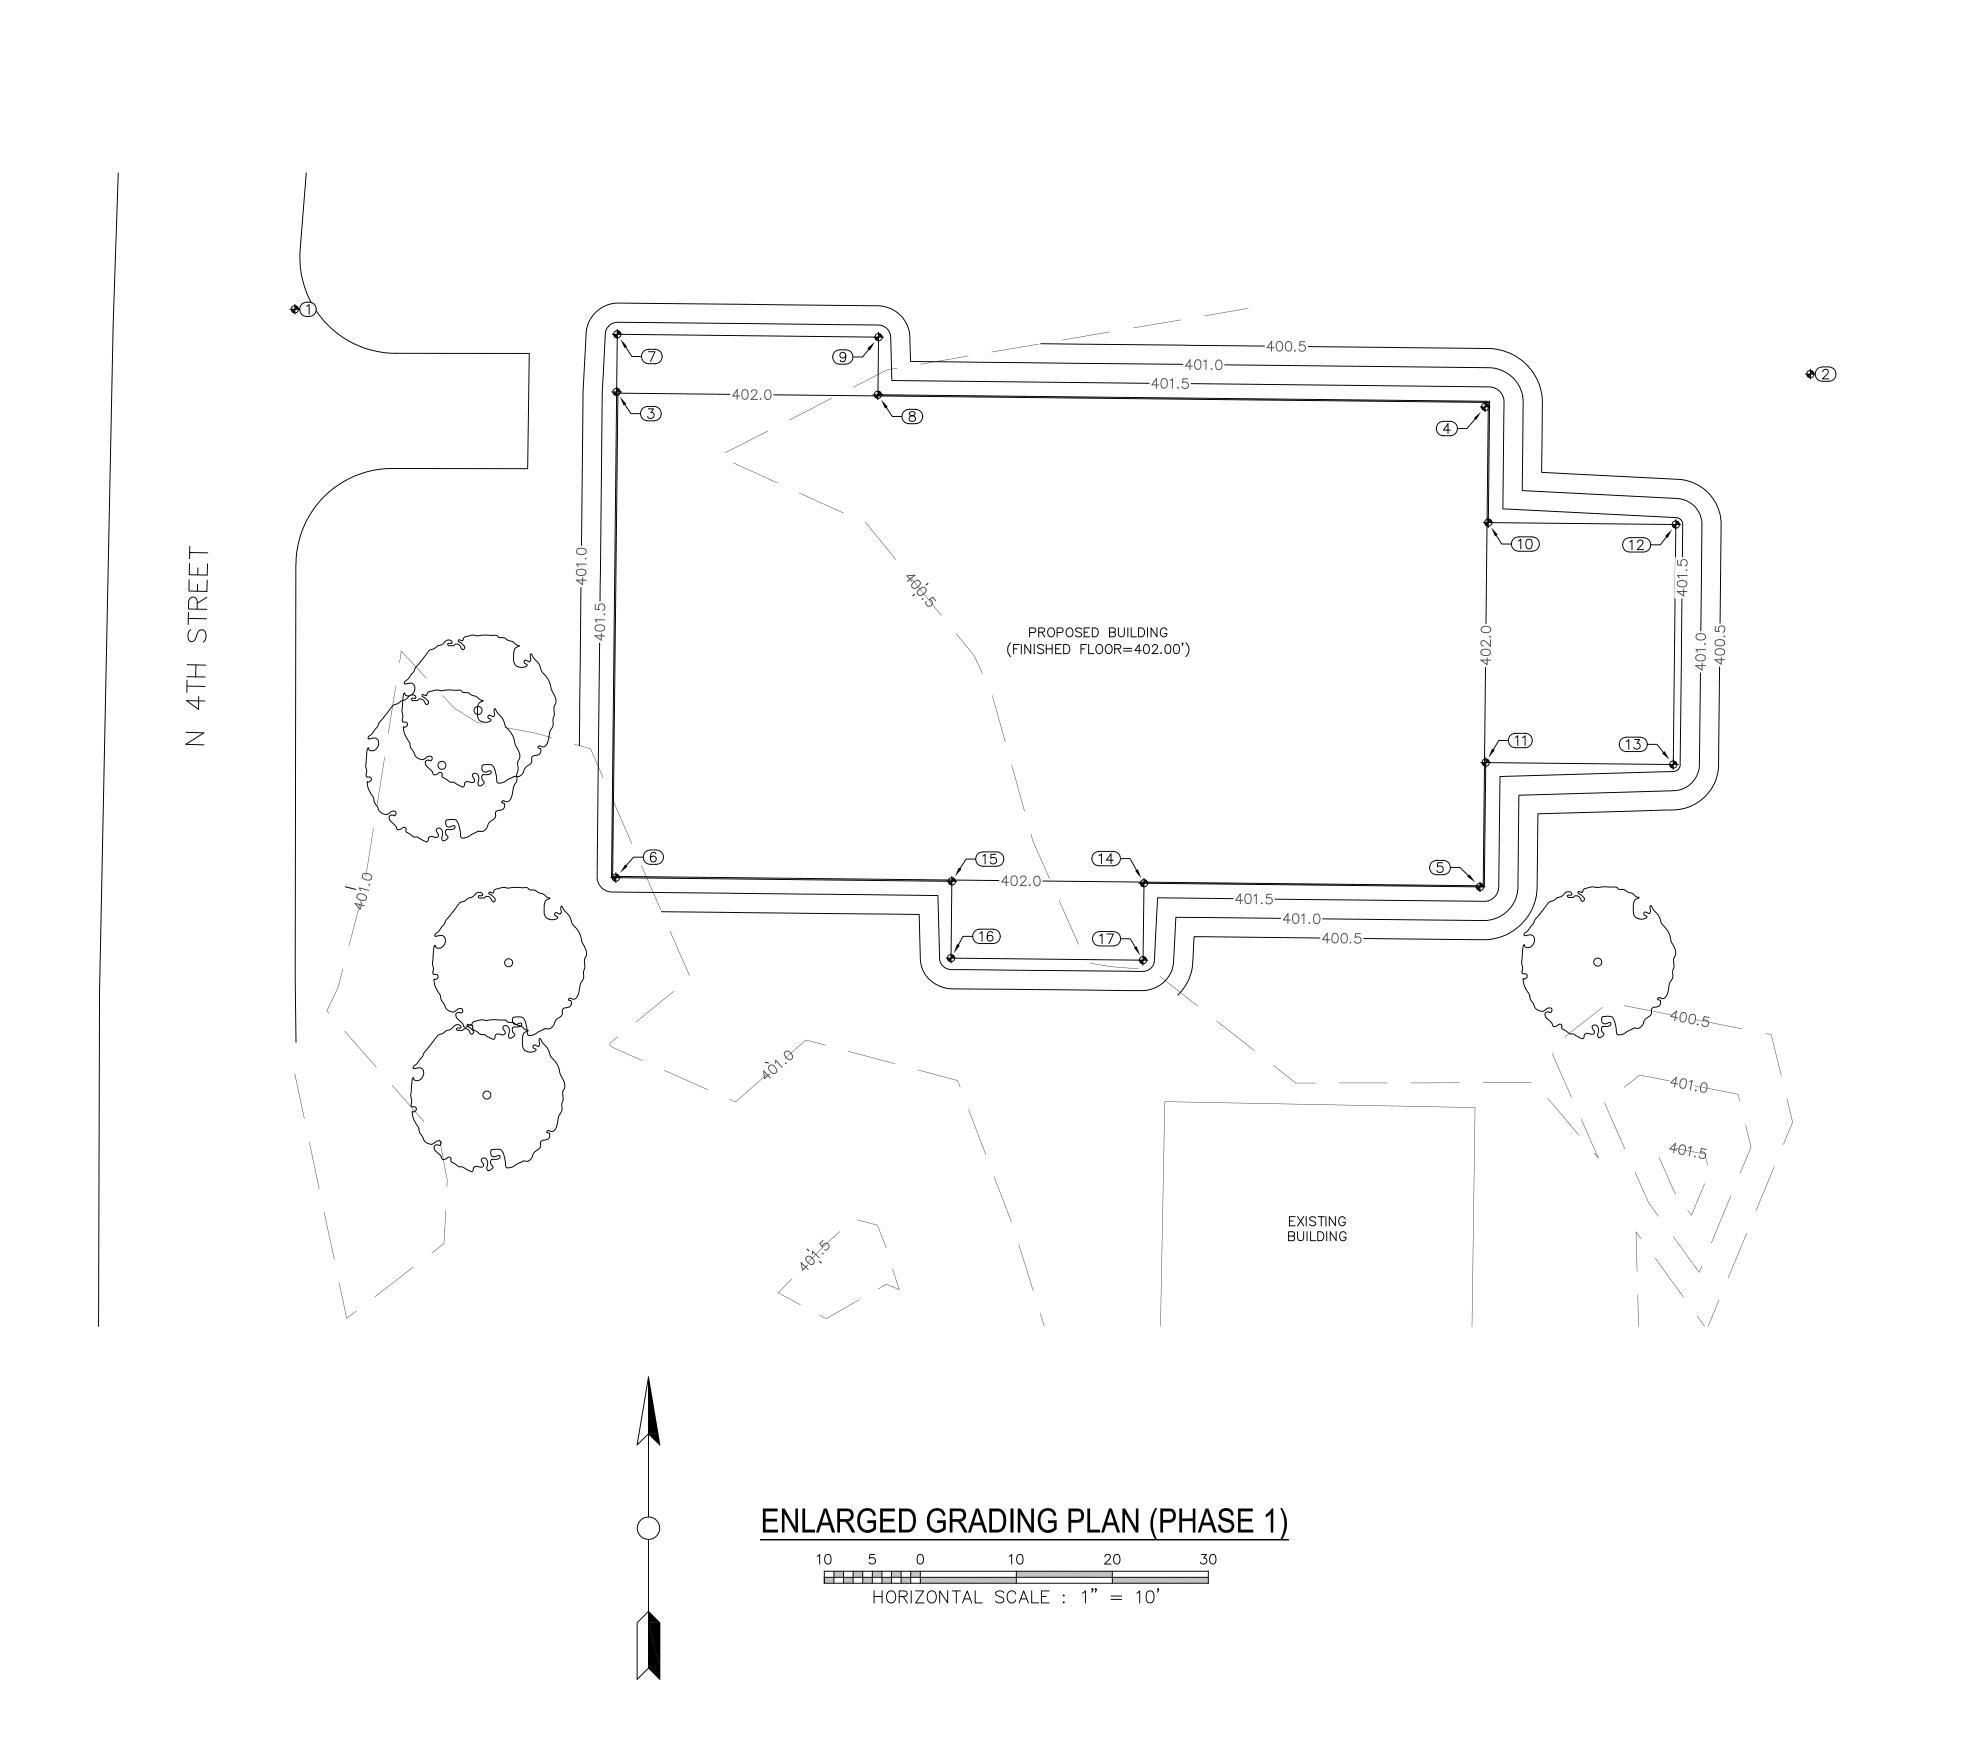SUBGRADE NOTES

SUBGRADE PREPARATION:

1. SUBGRADE PREPARATION REQUIREMENTS ARE BASED ON RECOMMENDATIONS PROVIDED BY EARTHLOK. THESE RECOMMENDATIONS STATE THAT THE BUILDING PAD (5'-0" BEYOND FOUNDATION) BE CHEMICALLY INJECTED TO A DEPTH OF 7'-0" OR TO IMPENETRABLE MATERIAL IN ORDER TO REDUCE THE SWELL TO AN AVERAGE OF 1% OF INJECTED DEPTH. INJECTIONS SHALL BE ON A MAXIMUM OF 4 FOOT CENTERS.

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ED BY
AYLOR, P.E.

ADMINIS I RATION BLDG FRUITVALE, TEXAS 75127 NLARGED GRADING PLAN (PHASE 1



Issue/Revision Date & Description
IFB: 7-1-21

Job Number: 050-21003

Sheet Number:

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GENERAL NOTES:

GENERAL NOTES

- 1. THESE DRAWINGS ARE ISSUED TO INDICATE THE GENERAL SCOPE OF THE PROJECT IN TERMS OF THE STRUCTURAL DESIGN CONCEPT
- CONTRACTOR IS TO FURNISH ALL ITEMS REQUIRED FOR PROPER COMPLETION OF THE WORK WITHOUT ADJUSTMENT TO CONTRACT PRICE. COMPLETED WORK SHALL BE OF SOUND AND QUALITY CONSTRUCTION AND THE CONTRACTOR SHALL BE SOLELY RESPONSIBLE FOR THE INCLUSION OF ADEQUATE AMOUNTS TO COVER INSTALLATION OF ALL ITEMS INDICATED DESCRIBED OR IMPLIED, TO PERFORM THE INTENDED FUNCTIONS SPECIFIED IN THE CONSTRUCTION DOCUMENTS.
- 3. THE DETAILS DESIGNATED AS "TYPICAL DETAILS" APPLY GENERALLY TO THE DRAWINGS IN AREAS WHERE CONDITIONS ARE SIMILAR TO THOSE DESCRIBED IN THE DETAILS, UNLESS NOTED OTHERWISE. TYPICAL SECONDARY FRAMING AND PANEL/TRIM DETAILS ARE SHOWN FOR DESIGN INTENT. SUPPLIER/INSTALLER SHALL PROVIDE THEIR STANDARD SECONDARY FRAMING AND PANEL/TRIM DETAILS TO ENGINEER FOR APPROVAL PRIOR TO FABRICATION.
- LALL DIMENSIONS SHALL TAKE PRECEDENCE OVER SCALE SHOWN ON PLANS, SECTIONS AND DETAILS. DO NOT SCALE THE DRAWINGS. DIMENSIONS ARE TO FACE OF COLUMN (F.O.C.), CENTER OF COLUMN (C.O.C.) FACE OF CHANNEL (F.O.CH.), FACE OF WALL (F.O.W.), FACE OF EXISTING STRUCTURE AND EXTERIOR FACE OF ANGLE LEGS.
- PRINCIPAL OPENINGS, CURBS AND SLAB DEPRESSIONS ARE SHOWN ON THE DRAWINGS. SEE ARCHITECTURAL, CIVIL, MECHANICAL, ELECTRICAL AND PLUMBING DRAWINGS FOR SLEEVES, CURBS, INSERTS, OTHER OPENINGS AND SLAB DEPRESSIONS NOT SHOWN. THE CONTRACTOR SHALL PROVIDE FOR ALL OPENINGS, CURBS, AND SLAB DEPRESSIONS WHETHER SHOWN ON THE STRUCTURAL DRAWINGS OR NOT. SIZES AND LOCATIONS OF OPENINGS, CURBS AND DEPRESSIONS SHALL BE VERIFIED BY THE CONTRACTOR BY REVIEWING LAYOUT OF THE AREA ON THE ARCHITECTURAL DRAWINGS.
- 6. THE CONTRACTOR SHALL COMPARE THE STRUCTURAL DRAWINGS WITH THE ARCHITECTURAL, MECHANICAL, ELECTRICAL, PLUMBING AND CIVIL DRAWINGS TO CONFIRM ALL REQUIREMENTS OF THE WORK. REPORT ANY CONFLICT/DISCREPANCY BETWEEN THE DISCIPLINES TO THE DESIGN PROFESSIONAL PRIOR TO EXECUTION OF THE WORK.
- THE CONTRACTOR SHALL INSURE THAT ALL CONSTRUCTION LOADS DO NOT EXCEED THE DESIGN LIVE LOADS INDICATED ON THE STRUCTURAL DRAWINGS AND THAT THESE LOADS
- ARE NOT PUT ON THE STRUCTURAL MEMBERS PRIOR TO THE TIME THAT THE FRAMING MEMBERS, BRACING MEMBERS AND CONNECTIONS ARE IN PLACE.
- 8. THE CONTRACTOR IS RESPONSIBLE FOR ALL TEMPORARY BRACING AND SHORING REQUIRED FOR COMPLETION OF THE WORK.
- 9. THE CONTRACTOR IS RESPONSIBLE FOR THE MEANS AND METHODS EMPLOYED FOR THE COMPLETION OF THE PROJECT.
- 10. THE CONTRACTOR SHALL OBTAIN ALL PERMITS NECESSARY FOR COMPLETION OF THE WORK.
- 11. THE CONTRACTOR SHALL ARRANGE ALL REQUIRED INSPECTIONS.

DESIGN CODES AND LOADS

- 1. BUILDING CODE: 2015 IBC
- STRUCTURAL CONCRETE: BUILDING CODE REQUIREMENTS FOR REINFORCED CONCRETE, ACI 318.
- 3. STRUCTURAL STEEL: MANUAL OF STEEL CONSTRUCTION, AMERICAN INSTITUTE OF STEEL CONSTRUCTION.
- 4. MASONRY: BUILDING CODE REQUIREMENTS AND SPECIFICATION FOR MASONRY STRUCTURES, ACI 530.
- 5. DESIGN WIND LOAD CRITERIA:
- RISK CATEGORY 2
- WIND VELOCITY 115MPH
- EXPOSURE C
- ENCLOSED BUILDING
- DESIGNED WITH DIRECTION PROCEDURE.
 DESIGN LIVE LOAD:
- ROOF 20PSF (REDUCIBLE)
- MEZZANINE 125PSF
 DESIGN DEAD LOAD:
- BUILDING COMPONENT SELF WEIGHT
- COLLATERAL 5PSF

CONCRETE NOTES

CAST-IN-PLACE CONCRETE:

CONTINUOUSLY.

1. MATERIALS

A. PORTLAND CEMENT SHALL CONFORM TO THE STANDARD SPECIFICATIONS FOR PORTLAND CEMENT, ASTM DESIGNATION C-150, LATEST VERSION TYPE II.
 B. CONCRETE AGGREGATES, ASTM C-33. THE MAXIMUM SIZE SHALL NOT BE LARGER

THAN 11/8" INCHES FOR SLABS ON GRADE, 3/4" INCHES FOR CONCRETE FILL OVER

- FORMED OR COMPOSITE DECKS.

 C. WATER SHALL BE CLEAN, POTABLE, AND FREE OF INJURIOUS AMOUNTS OF ACIDS,
- ALKALOIDS, OR ORGANIC MATTER.

 D. READY MIX CONCRETE SHALL CONFORM TO ASTM SPECIFICATION C-94, LATEST
- VERSION.
- E. ADMIXTURES USED TO ASSIST THE WORKABILITY OF CONCRETE SHALL CONFORM TO ASTM SPECIFICATIONS C-260 AND C-494, LATEST VERSION. ADMIXTURES MUST BE APPROVED BY THE ENGINEER.
- 2. CAST-IN-PLACE CONCRETE SHALL HAVE A COMPRESSIVE STRENGTH AT 28 DAYS OF 4000 PSI, A MIN. SLUMP 3", MAX SLUMP 5", MIN. AIR CONTENT 3%, MAX. AIR CONTENT 5%, MIN. WATER TO CEMENT RATIO .45, MAX WATER TO CEMENT RATIO .55.
- 3. INTERIOR CONCRETE SLAB SURFACE SHALL RECEIVE FLOAT FINISH. EXTERIOR SLAB SURFACES SHALL RECEIVE MEDIUM BROOM FINISH. SEAL SLAB WITH CLEAR CONCRETE SEALER EQUIVALENT TO PRODUCTS PRODUCED BY WR MEADOWS OR SIKA.
- . CONTINUOUS REINFORCING BARS SHALL HAVE A MINIMUM OVERLAP OF 30 DIAMETERS OR 24 INCHES, WHICHEVER IS GREATER.
- 5. PROVIDE CORNER BARS IN GRADE BEAMS AND FOOTINGS AT EACH CORNER AND/OR INTERSECTION (TOP AND BOTTOM).
- 6. PROVIDE CONTROL JOINTS (SAWED, FORMED OR TOOLED) WHERE SHOWN ON PLAN, PROVIDE CONSTRUCTION JOINTS WHERE SECTIONS CAN NOT BE PLACED
- 6.1. FOR MAT SLAB JOINTS PROVIDE SIKA LOADFLEX -524 EZ (OR EQUAL)
 TWO-COMPONENT, QUICK-SETTING, SEMI-RIGID, SOLVENT-FREE, SELF-LEVELING
 CONTROL JOINT FILLER AFTER CONTROL JOINTS ARE PLACED. SELECTED FILLER
 SHALL HAVE A SHORE D HARDNESS OF 30-32 AND SHORE A HARDNESS OF
 80-85.
- 6.2. FOR EXTERIOR SLAB/WALL JOINTS PROVIDE MIN.¾" DEEP JOINT SEALANT OVER BACKER ROD. PROVIDE W.R. MEADOWS POURTHANE NS NON—SAG JOINT SEALANT OR EQUIVALENT.
- 7. PROVIDE ½" WIDE MINIMUM EXPANSION/ISOLATION JOINTS IN FLOOR SLAB AS SHOWN ON DRAWINGS. EXPANSION/ISOLATION JOINTS, SHALL HAVE PRE-MOLDED JOINT FILLERS THAT MEET THE REQUIREMENTS OF ASTM SPECIFICATIONS D-994, LATEST VERSION. JOINT SHALL HAVE ½" DEEP SELF LEVELING JOINT SEALANT. PROVIDE W.R. MEADOWS POURTHANE NS NON-SAG JOINT SEALANT OR EQUIVALENT.
- 8. ALL REINFORCING SHALL BE SUPPORTED ON METAL OR PLASTIC SUPPORTS AND SECURELY TIED TO PREVENT MOVEMENT DURING CONCRETING.
- 9. REINFORCING BARS SHALL CONFORM TO ASTM A 615 GRADE 60, EXCEPT TIES AND STIRRUPS MAY BE GRADE 40.

- 10. WELDED WIRE FABRIC SHALL CONFORM TO ASTM A-185, FABRIC SHALL BE SUPPLIED IN FLAT SHEETS AND SHALL BE LAPPED 2 MESHES AT SPLICES.
- 11. CONCRETE PROTECTION FOR REINFORCING BARS: DEPOSITED AGAINST EARTH 3", EXPOSED TO WEATHER OR EARTH 2", 1½" AT TOP OF INTERIOR SLABS.
- 12. CONDUIT FOR ELECTRICAL OR PLUMBING LINES SHALL BE SLEEVED THROUGH GRADE BEAMS.
- 13. ALL DRILLED/EPOXY SET ANCHORS OR DOWELS SHALL BE AS MANUFACTURED BY HILTI. CAST IN ANCHORS SHALL BE ASTM F1554 GRADE 36.
- 14. CONTRACTOR SHALL MAKE PROVISIONS FOR FINISHING EXPOSED CONCRETE. AS SOON AS FORMS ARE REMOVED, UNDESIRABLE FINS AND PROJECTIONS SHALL BE REMOVED, OFFSETS SHALL BE LEVELED, AND VOID OR DAMAGED PLACES SHALL BE IMMEDIATELY SATURATED WITH WATER AND FINISHED WITH CEMENTIOUS PASTE OR MORTAR OF THE SAME COMPOSITION AS USED IN THE MIX. EXPOSED SURFACES SHALL BE RUBBED WITH CARBORUNDUM STONE TO A SMOOTH FINISH FREE FROM FORM MARKS OR HONEYCOMBS.
- 15. CONCRETE SHALL BE PLACED CONTINUOUSLY, WITHOUT INTERRUPTION, IN SUCH A MANNER AS NOT TO CAUSE SEGREGATION. EACH LIFT SHALL BE VIBRATED. WHERE CONCRETE DROPS ARE MORE THAN 5 FEET, CONCRETE SHALL BE PLACED USING A CHUTE, TREMIE, OR PUMP HOSE.
- 16. FOUNDATION CONTRACTOR SHALL PROVIDE AND INSTALL ALL ANCHOR BOLTS AND EMBEDDED ITEMS.
- 17. TESTING LABORATORY SERVICES FOR QUALITY CONTROL OF CAST-IN-PLACE CONCRETE SHALL BE PROVIDED BY THE OWNER. TESTING SERVICES SHALL INCLUDE PREPARATION AND TESTING OF CONCRETE COMPRESSION CYLINDERS AND SLUMP TESTS AS DIRECTED BY THE OWNER'S REPRESENTATIVE. REPORTS SHALL BE SUBMITTED IN DUPLICATE TO THE ENGINEER.
- 17.1. TEST CYLINDERS: DURING PROGRESS OF WORK, MOLD, CURE AND TEST SPECIMENS OF EACH DIFFERENT MIX DESIGN PLACED IN ANY ONE DAY. FOR EACH 50 CUBIC YARDS OF CONCRETE PLACED, OR PART THEREOF OVER 10 CUBIC YARDS, MAKE COMPRESSION TEST CYLINDERS DURING POUR. MOLD AND CURE TEST CYLINDERS IN ACCORDANCE WITH ASTM C-31. TEST CYLINDERS IN ACCORDANCE WITH ASTM C-39: ONE AT 7 DAYS AND 2 AT 28 DAYS. MAKE ADDITIONAL SETS OF 3 CYLINDERS WHEN OBVIOUS CHANGES IN MIX ARE APPARENT.
- 17.2. SLUMP TESTS: MAKE SLUMP TESTS FOR EACH 50 CUBIC YARDS AT CONCRETE PLACED, AND FOR EACH SET OF CYLINDERS IN ACCORDANCE WITH ASTM C143.
- 17.3. AIR CONTENT OF NORMAL—WEIGHT CONCRETE: DETERMINE TOTAL AIR CONTENT OF AIR ENTRAINED CONCRETE FOR EACH COMPRESSIVE STRENGTH TEST IN ACCORDANCE WITH ASTM C231.
- 18. FURNISH AND INSTALL 10 MIL POLYETHYLENE MEMBRANE VAPOR RETARDED UNDER ALL SLABS ON GRADE. VAPOR RETARDER SHEETS SHALL BE INSTALLED OVER LEVEL, COMPACTED GRANULAR SOIL WITH 6" JOINT LAPS. JOINT LAPS SHALL BE CONTINUOUSLY SEALED WITH DUCT TAPE. SEAL CAREFULLY AROUND ALL PIPES, CONDUITS, ETC., WHICH PENETRATE THE SLAB. SEAL ALL TEARS AND PUNCTURES PRIOR TO PLACING CONCRETE.

DRILLED PIER NOTES

- 1. REFER TO THE FOUNDATION DETAILS AND FOUNDATION PLAN FOR BEARING ELEVATION AND REINFORCING REQUIREMENTS.
- 2. REFER TO PLANS AND DETAILS FOR PIER AND CAP SIZES.
- 3. ALL PIER INSTALLATIONS SHALL BE INSPECTED BY OWNER'S REPRESENTATIVE.
- 4. THE DEPTHS OF PIERS SHALL BE VERIFIED BEFORE PIER STEEL IS CUT. PIER STEEL SHALL BE DELIVERED TO THE JOBSITE IN STANDARD STOCK LENGTHS AND CUT AS REQUIRED TO MATCH THE ACTUAL FIELD MEASURED DEPTH OF THE PIER. SPLICES IN VERTICAL REINFORCING ARE NOT PERMITTED. REINFORCING SHALL EXTEND TO WITHIN 3 INCHES FROM BOTTOM OF HOLE.
- 5. ACTUAL PIER DEPTHS SHALL BE REPORTED AND NOTED DURING CONSTRUCTION.
- PIER HOLES SHALL BE COMPLETED AND FILLED WITH CONCRETE WITHIN HE SAME DAY OF DRILLING.
- CONTRACTOR SHALL PROVIDE ADDITIONAL PIER REINFORCING STEEL (TIES AND VERTICAL
 REINFORCING), AS REQUIRED TO FACILITATE PLACEMENT OF THE REINFORCING CAGE WITHOUT
 BUCKLING, COLLAPSING OR EXCESSIVE DEFLECTION.
- 8. BASED ON SUBSURFACE CONDITIONS OBSERVED, THE INSTALLATION OF DRILLED STRAIGHT—SHAFTS WILL NOT REQUIRE THE USE OF SLURRY DISPLACEMENT METHOD AND/OR TEMPORARY STEEL CASING.
- 9. TESTING LABORATORY SERVICES FOR QUALITY CONTROL OF CAST—IN—PLACE CONCRETE SHALL BE PROVIDED BY THE OWNER. TESTING SERVICES SHALL INCLUDE PREPARATION AND TESTING OF CONCRETE COMPRESSION CYLINDERS AND SLUMP TESTS AS DIRECTED BY THE OWNER'S REPRESENTATIVE. REPORTS SHALL BE SUBMITTED IN DUPLICATE TO THE ENGINEER.
- 9.1. TEST CYLINDERS: DURING PROGRESS OF WORK, MOLD, CURE AND TEST SPECIMENS OF EACH DIFFERENT MIX DESIGN PLACED IN ANY ONE DAY. FOR EACH 50 CUBIC YARDS OF CONCRETE PLACED, OR PART THEREOF OVER 10 CUBIC YARDS, MAKE COMPRESSION TEST CYLINDERS DURING POUR. MOLD AND CURE TEST CYLINDERS IN ACCORDANCE WITH ASTM C-31. TEST CYLINDERS IN ACCORDANCE WITH ASTM C-39: ONE AT 7 DAYS AND 2 AT 28 DAYS. MAKE ADDITIONAL SETS OF 3 CYLINDERS WHEN OBVIOUS CHANGES IN MIX ARE
- 9.2. SLUMP TESTS: MAKE SLUMP TESTS FOR EACH 50 CUBIC YARDS AT CONCRETE PLACED, AND FOR EACH SET OF CYLINDERS IN ACCORDANCE WITH ASTM C143.
- 9.3. AIR CONTENT OF NORMAL—WEIGHT CONCRETE: DETERMINE TOTAL AIR CONTENT OF AIR ENTRAINED CONCRETE FOR EACH COMPRESSIVE STRENGTH TEST IN ACCORDANCE WITH ASTM C231.


PIER CONCRETE MIX

- 10. ADMIXTURES MAY BE USED TO CONTROL THE WORKABILITY OF THE CONCRETE MIX. THEY SHALL BE USED IN ACCORDANCE WITH THE MANUFACTURERS' RECOMMENDATIONS AND BE INCLUDED IN THE SUBMITTED MIX DESIGN FOR APPROVAL, THE USE OF CALCIUM CHLORIDE WILL NOT BE PERMITTED.
- 11. CEMENT SHALL BE TYPE II ASTM C 150.
- 12. DO NOT PLACE CONCRETE WITH SLUMP AND TEMPERATURE OUTSIDE THE LIMITS PROVIDED ON THE APPROVED MIX DESIGN.
- 13. CHANGING MATERIAL, PROPORTIONS, PROPERTIES, SOURCES OR ANYTHING WHICH IS A CHANGE
- IN THE APPROVED MIX DESIGN REQUIRES A NEW MIX DESIGN SUBMITTAL.
- 14. PROVIDE CONCRETE AS FOLLOWS: 28 DAY F'C = 3,000 PSI, MAX SLUMP 6-8 IN, AGG TYPE HARD ROCK, MAX SIZE $1\frac{1}{2}$ "

STORM SHELTER NOTES:

STORM SHELTER DESIGN CODES AND LOADS


- 1. BUILDING CODE: 2015 IBC
- 2. ICC 500, 2014
- 3. DESIGN WIND LOAD CRITERIA:
- WIND VELOCITY 250MPH
 EXPOSURE C
- GCpi = ± 0.55
- Kzt = 1.0
- Kd = 1.0
 DESIGNED WITH DIRECTION PROCEDURE
- VERTICAL AND HORIZONTAL SURFACE MISSILE PROJECTILE
- REQUIREMENTS ARE MET.
- 4. DESIGN LIVE LOAD:ROOF 125PSF
- 5. DESIGN DEAD LOAD:
- BUILDING COMPONENT SELF WEIGHT
- COLLATERAL 5PSF

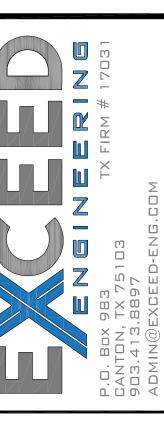

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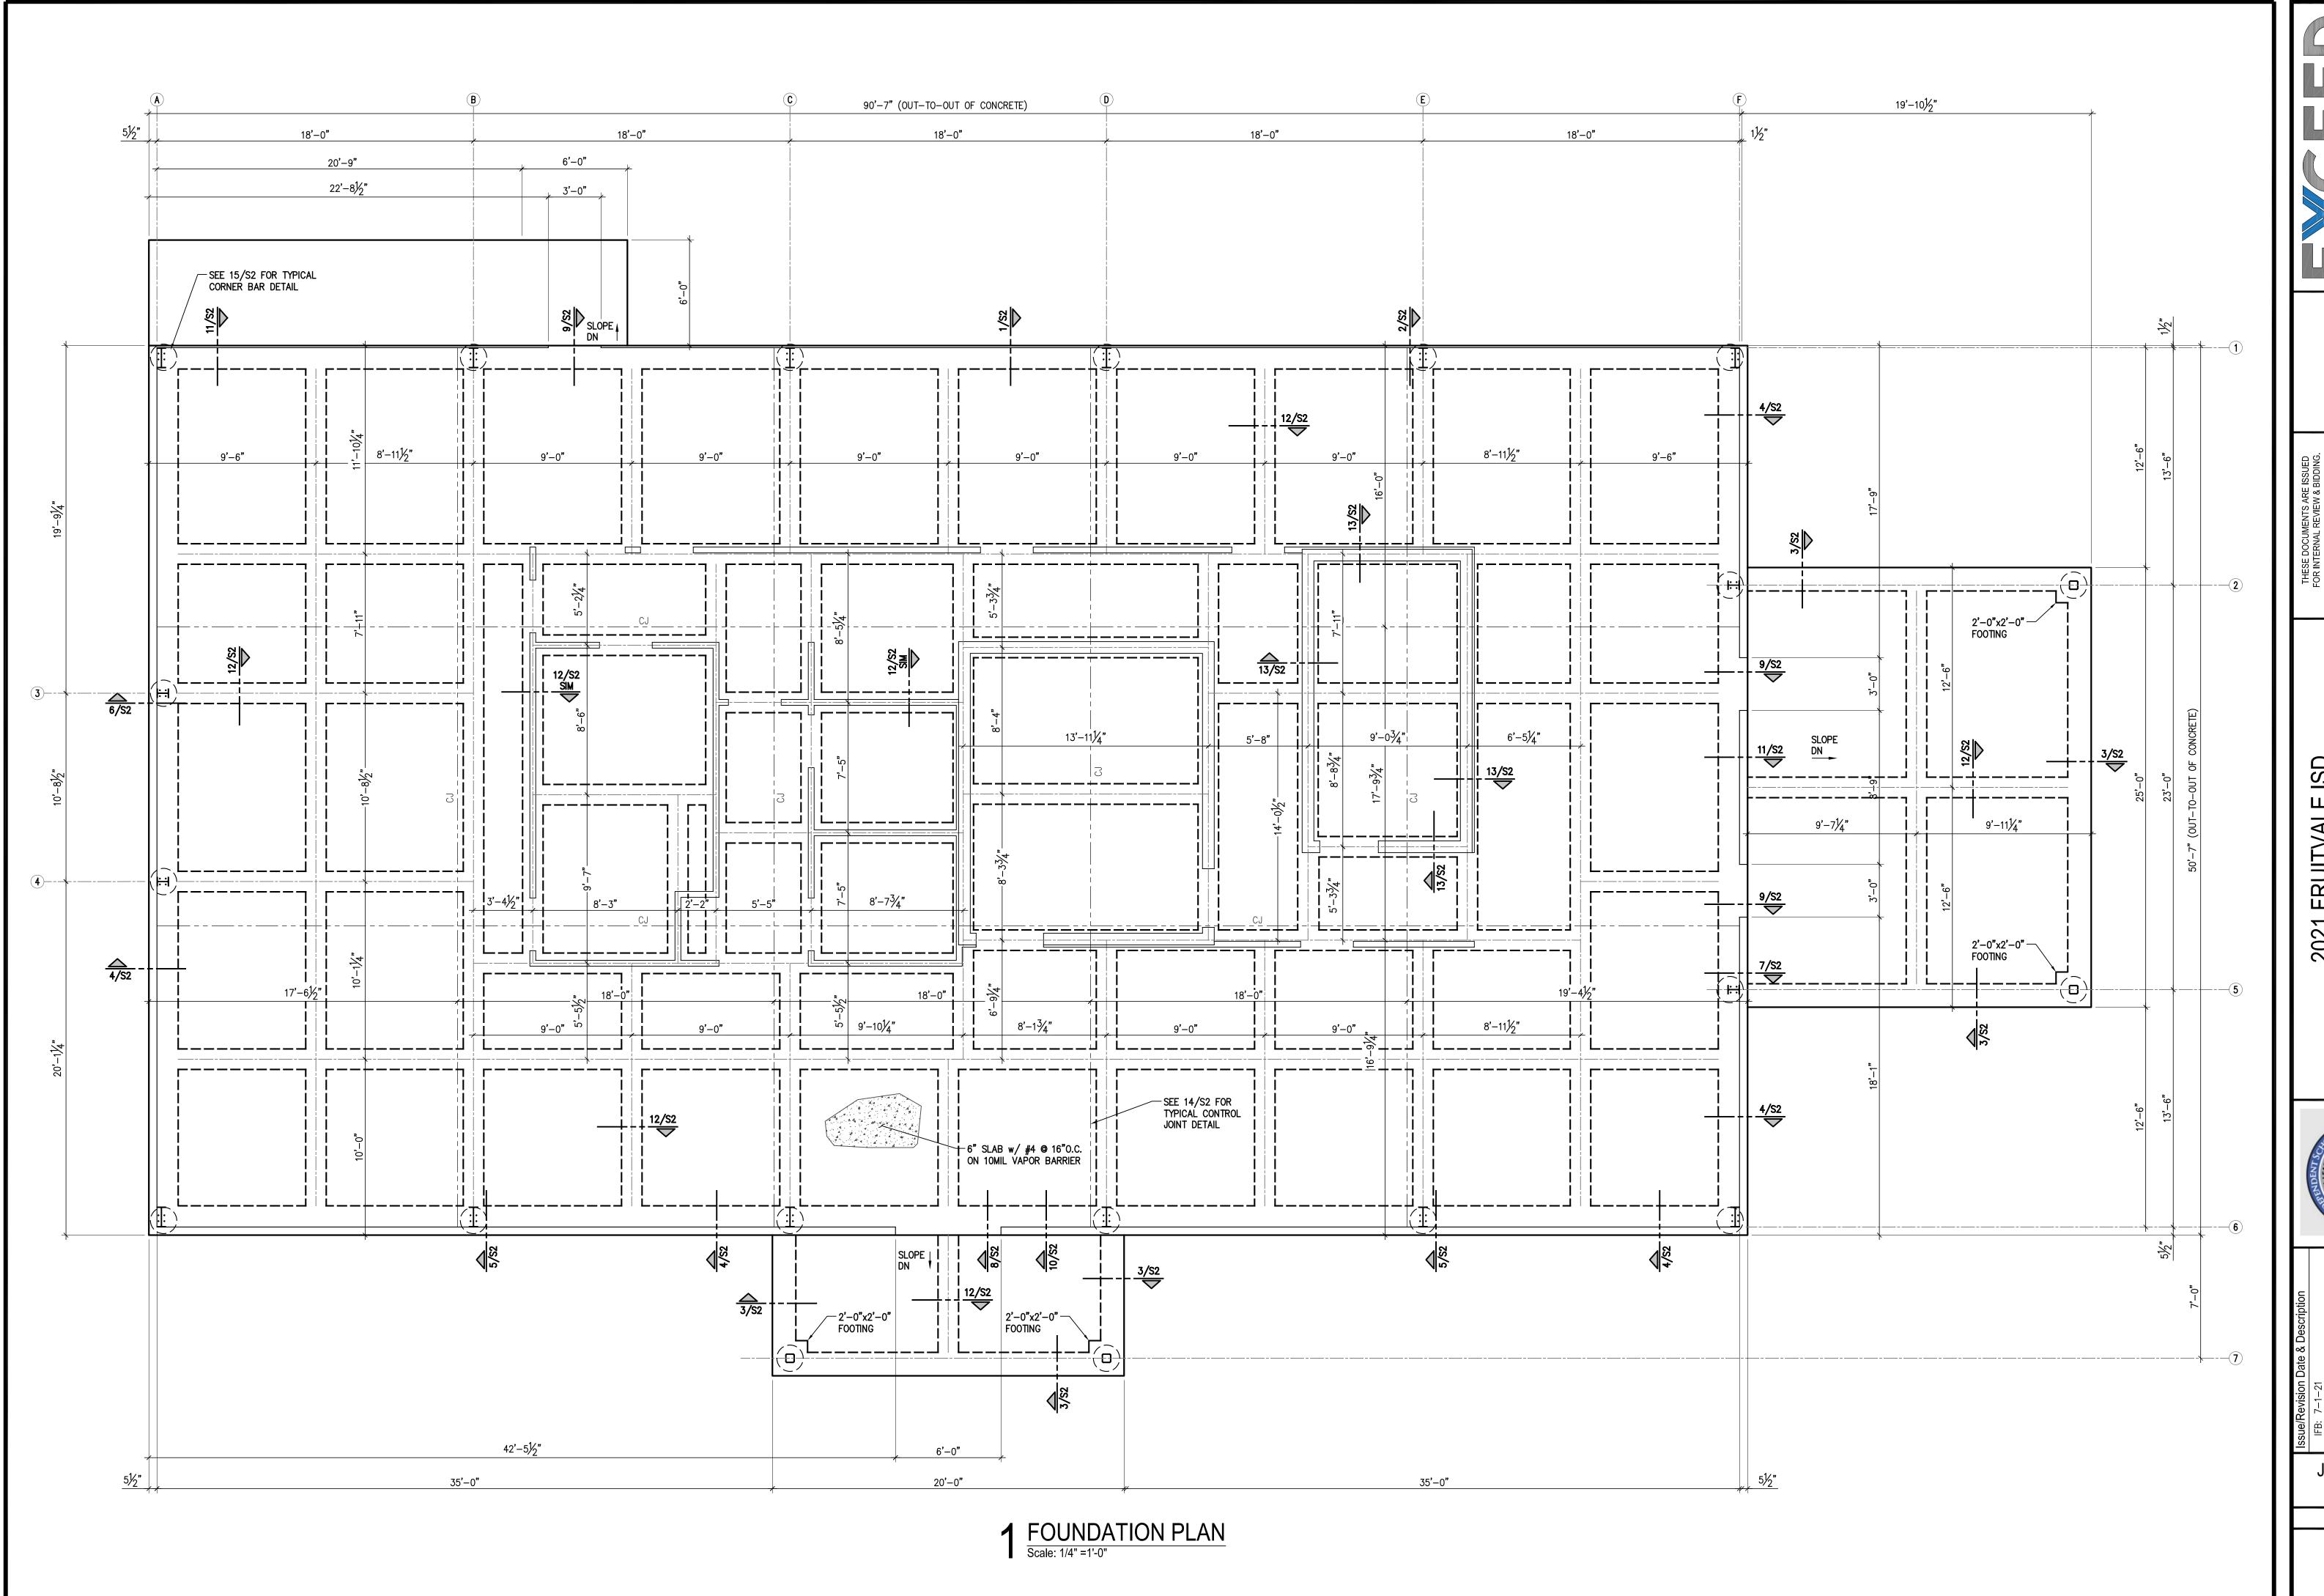




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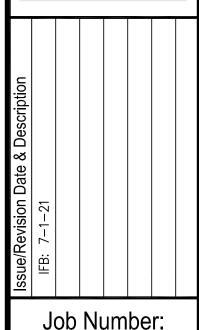

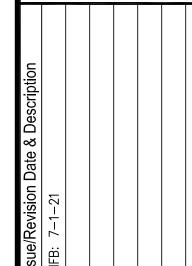
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2021 FRUITVALE ISD ADMINISTRATION BLDG FRUITVALE, TEXAS 75127 FOUNDATION PLAN






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P.O. BOX 983

TX FIRM # 170

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903.413.8897
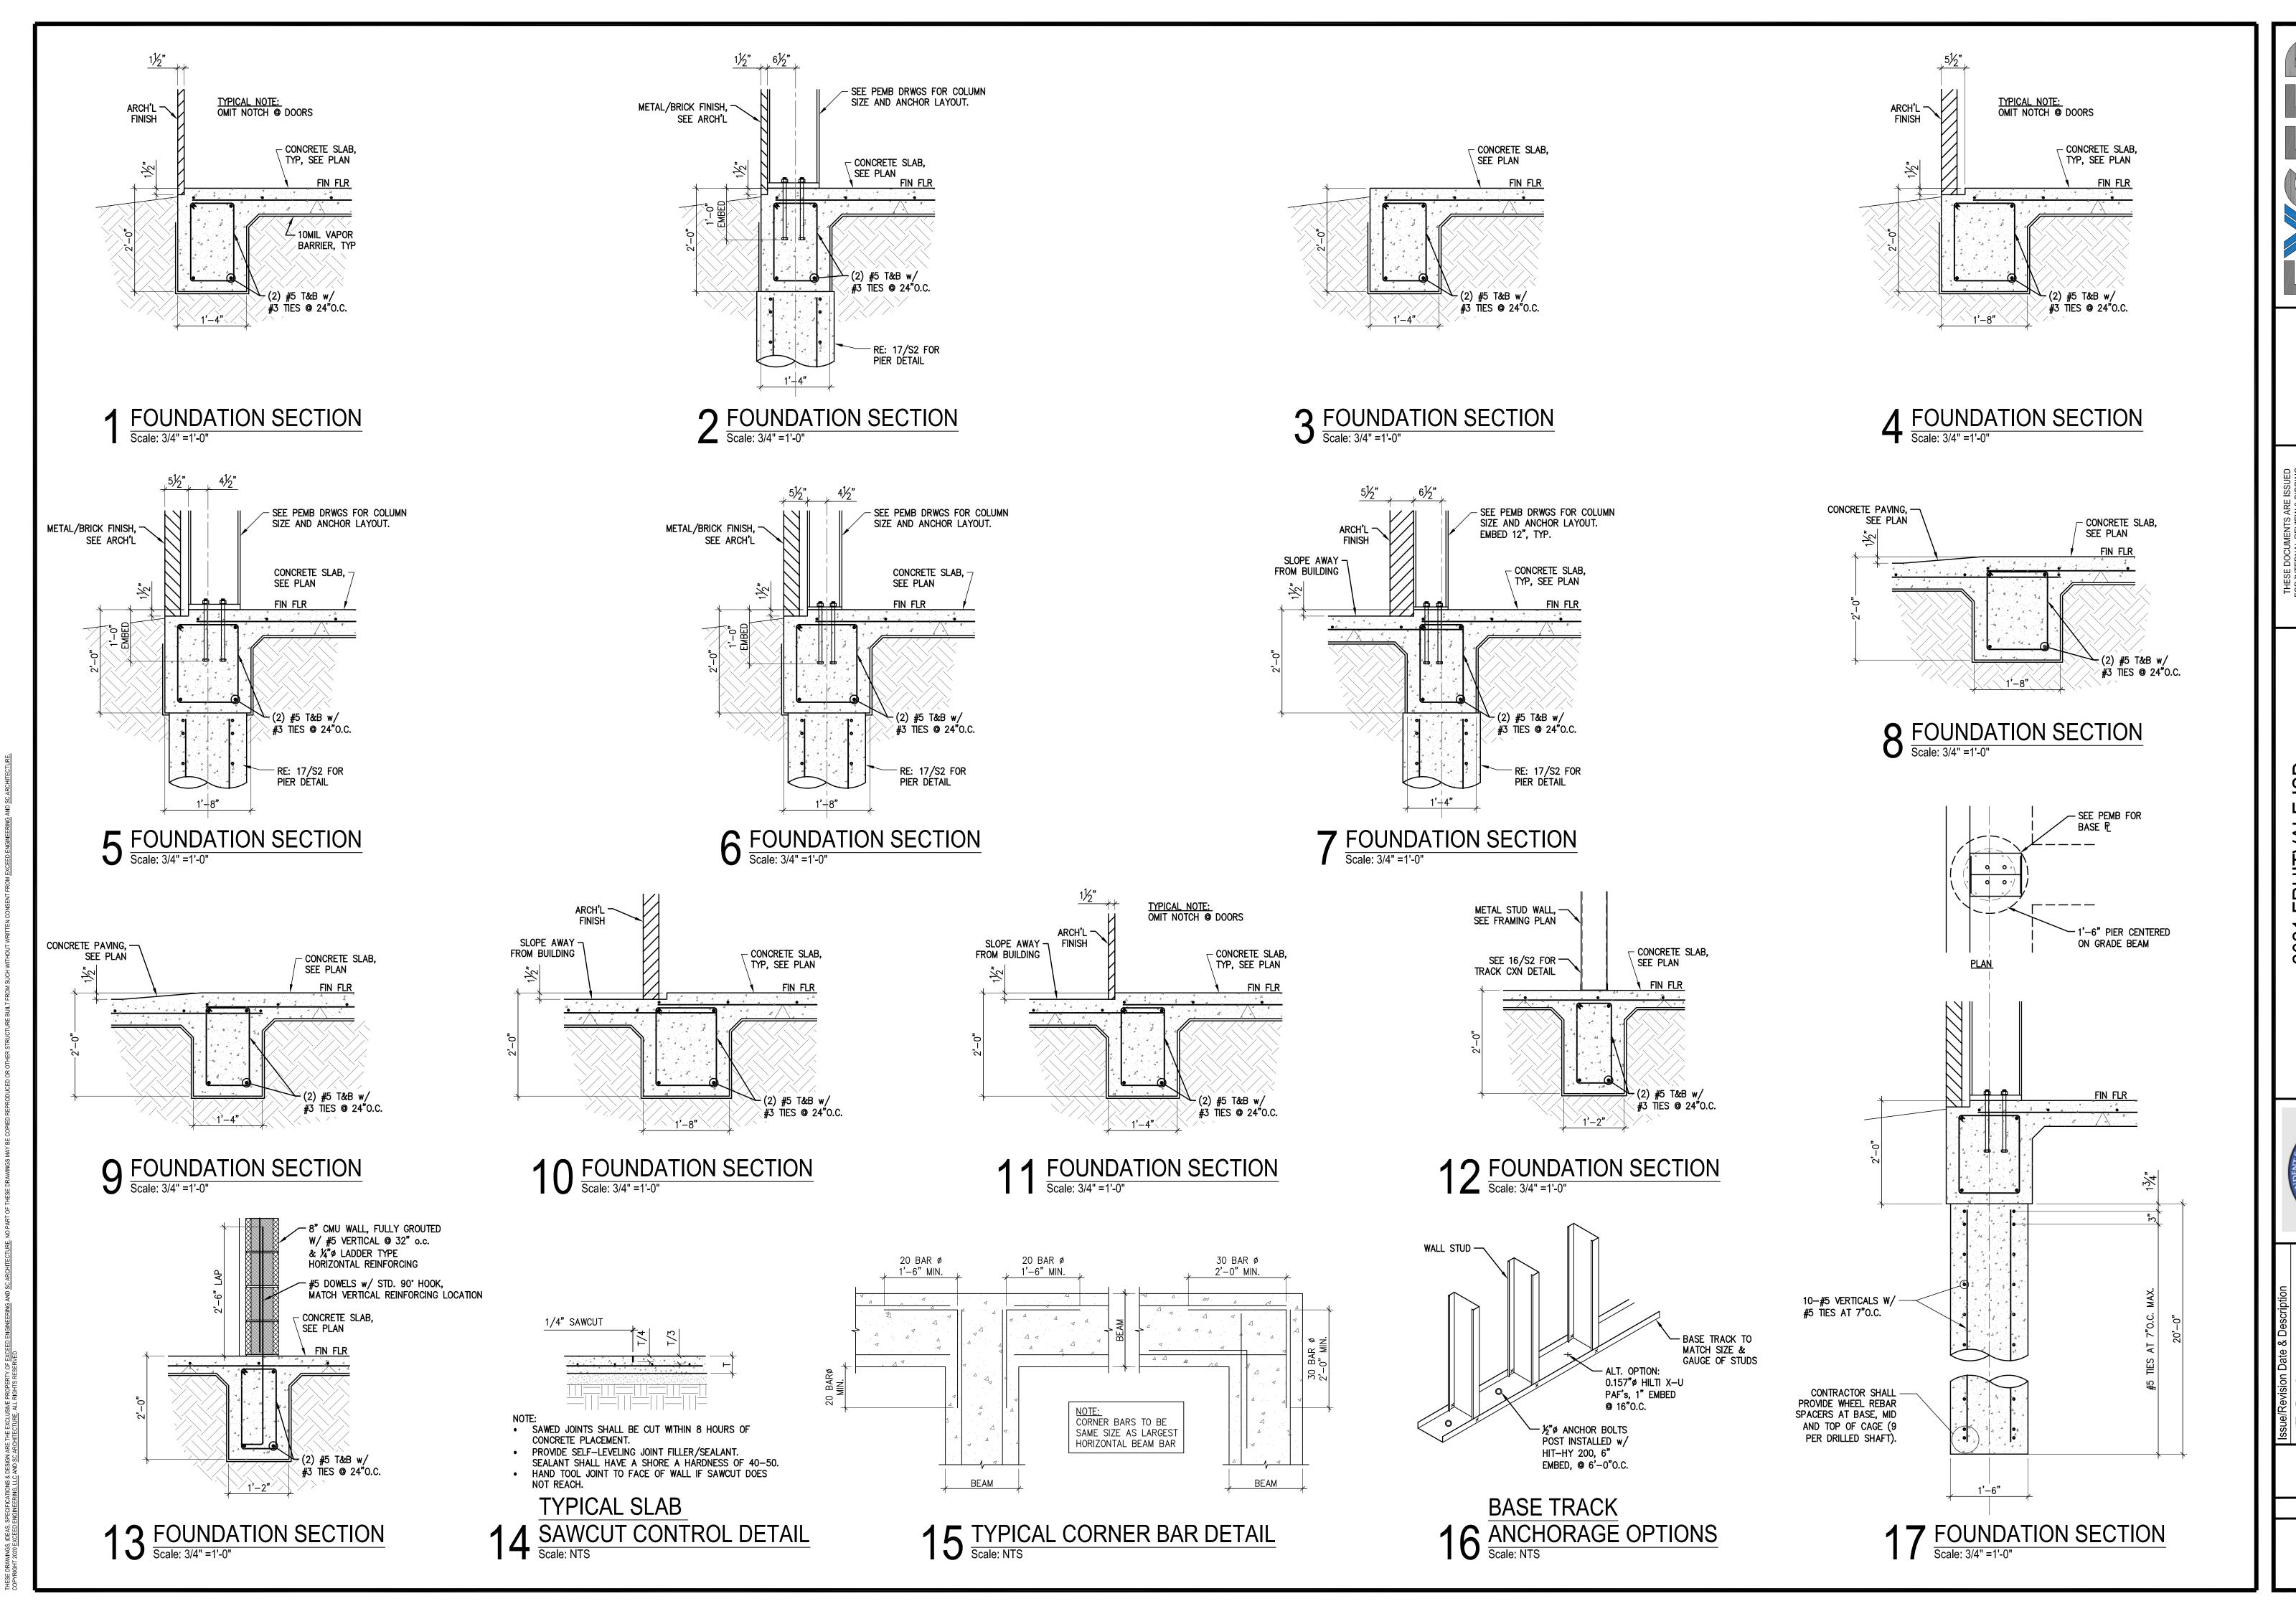
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FRUITVALE, TEXAS 75127



Issue/Revision Date & Description

IFB: 7-1-21

Open Substitution

IFB: 7-1-21

Substitution


IFB: 7-1-21

IFB: 7-1-21

IFB: 7-1-21


050-21003
Sheet Number:

S2

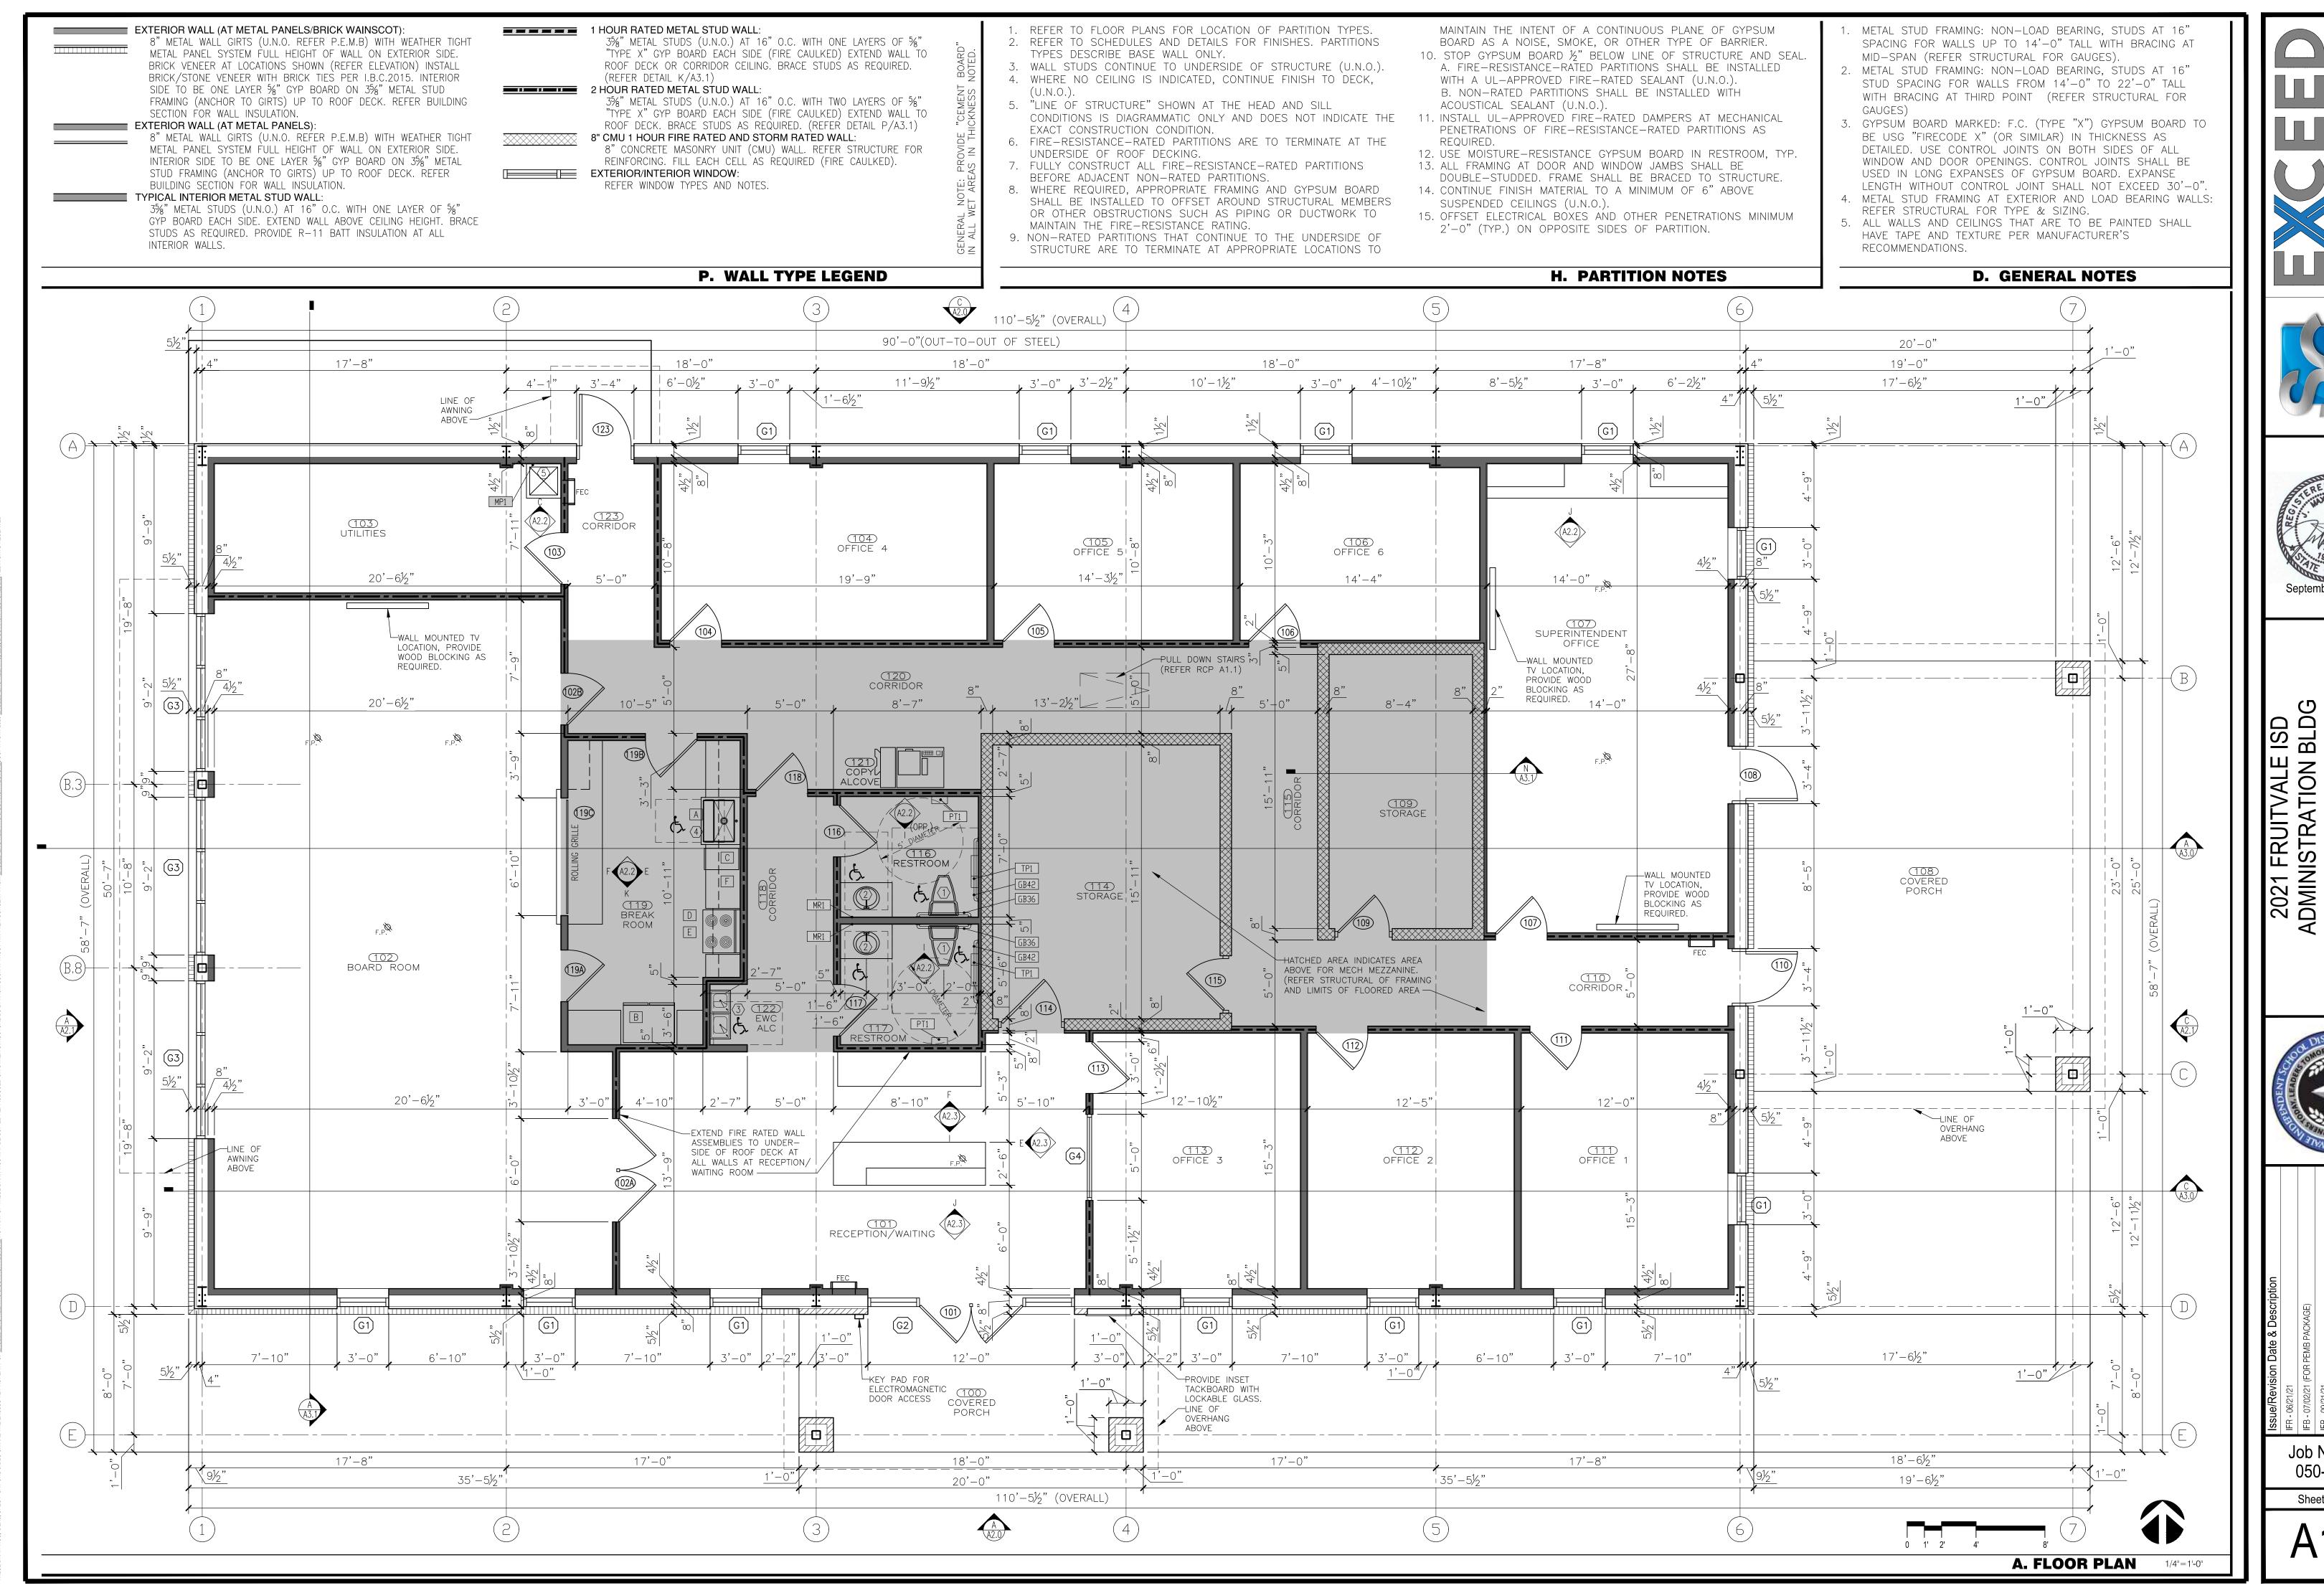


September 21, 2021

Job Number 050-21003

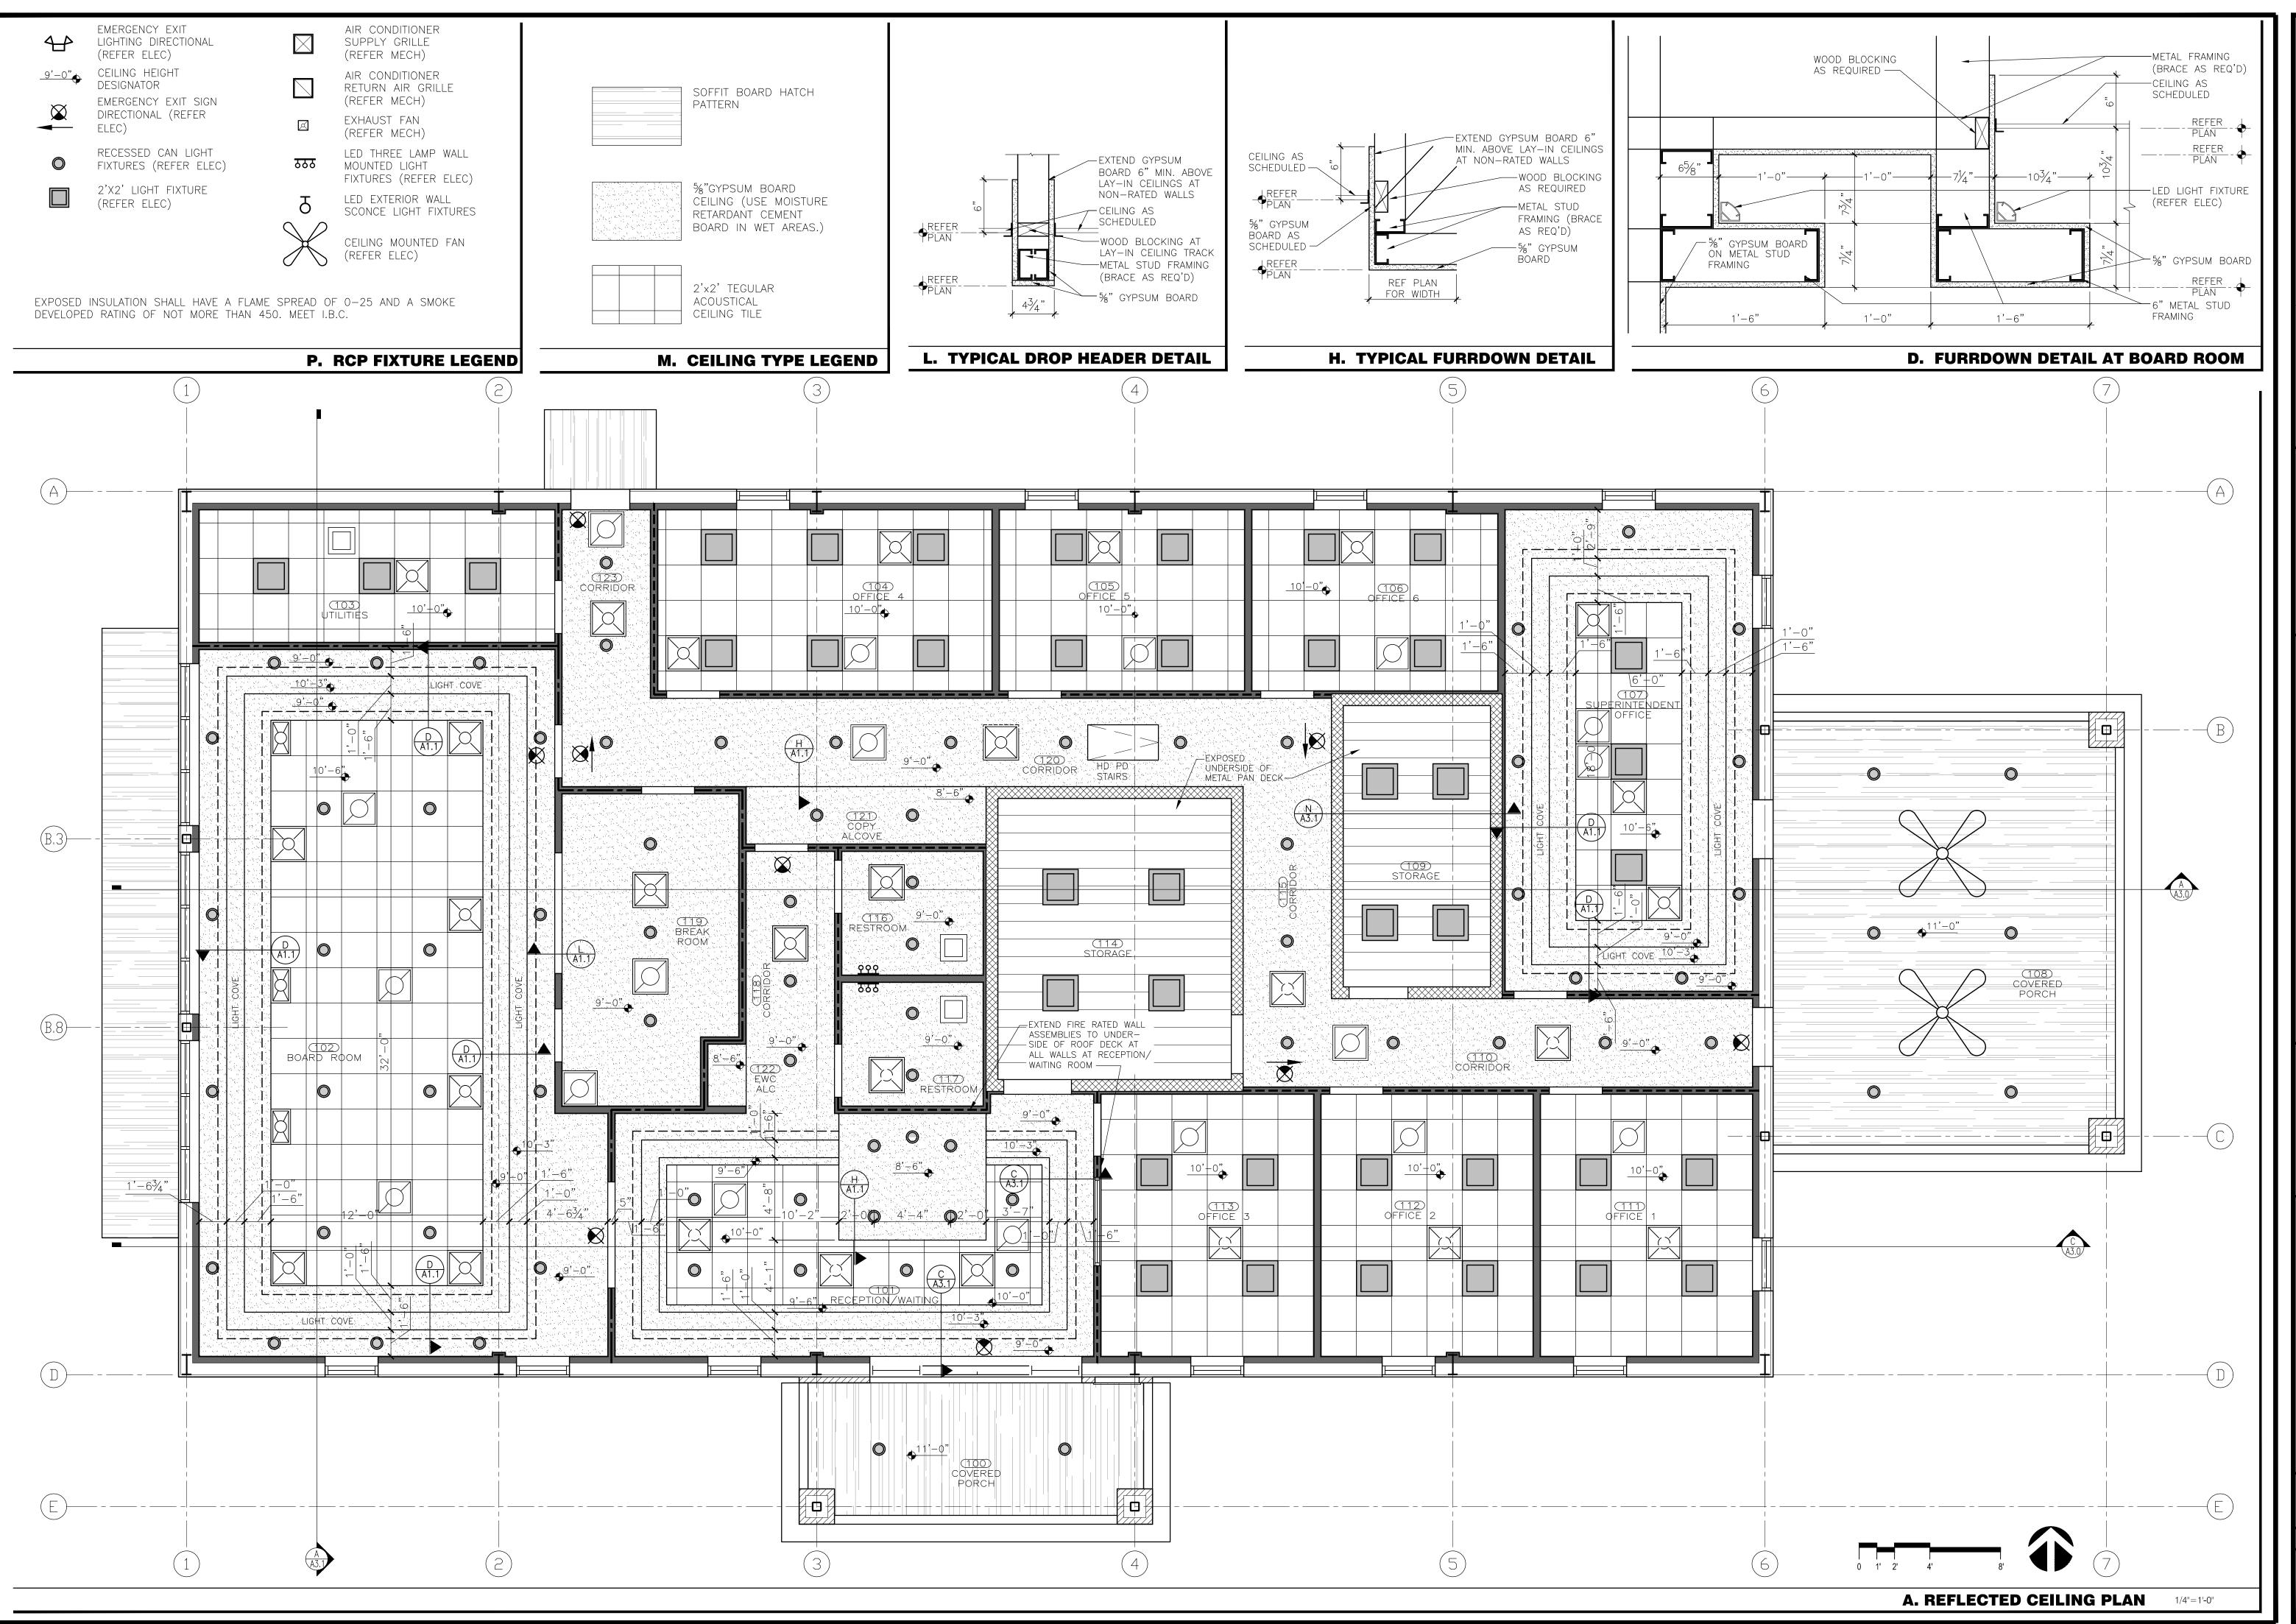




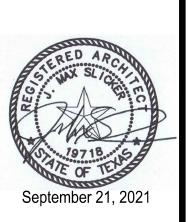


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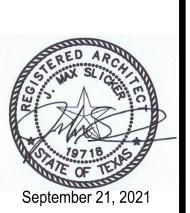


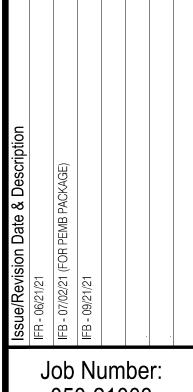


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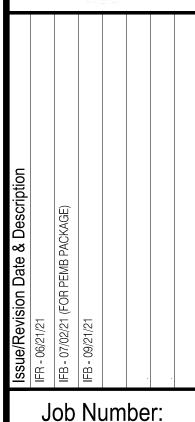
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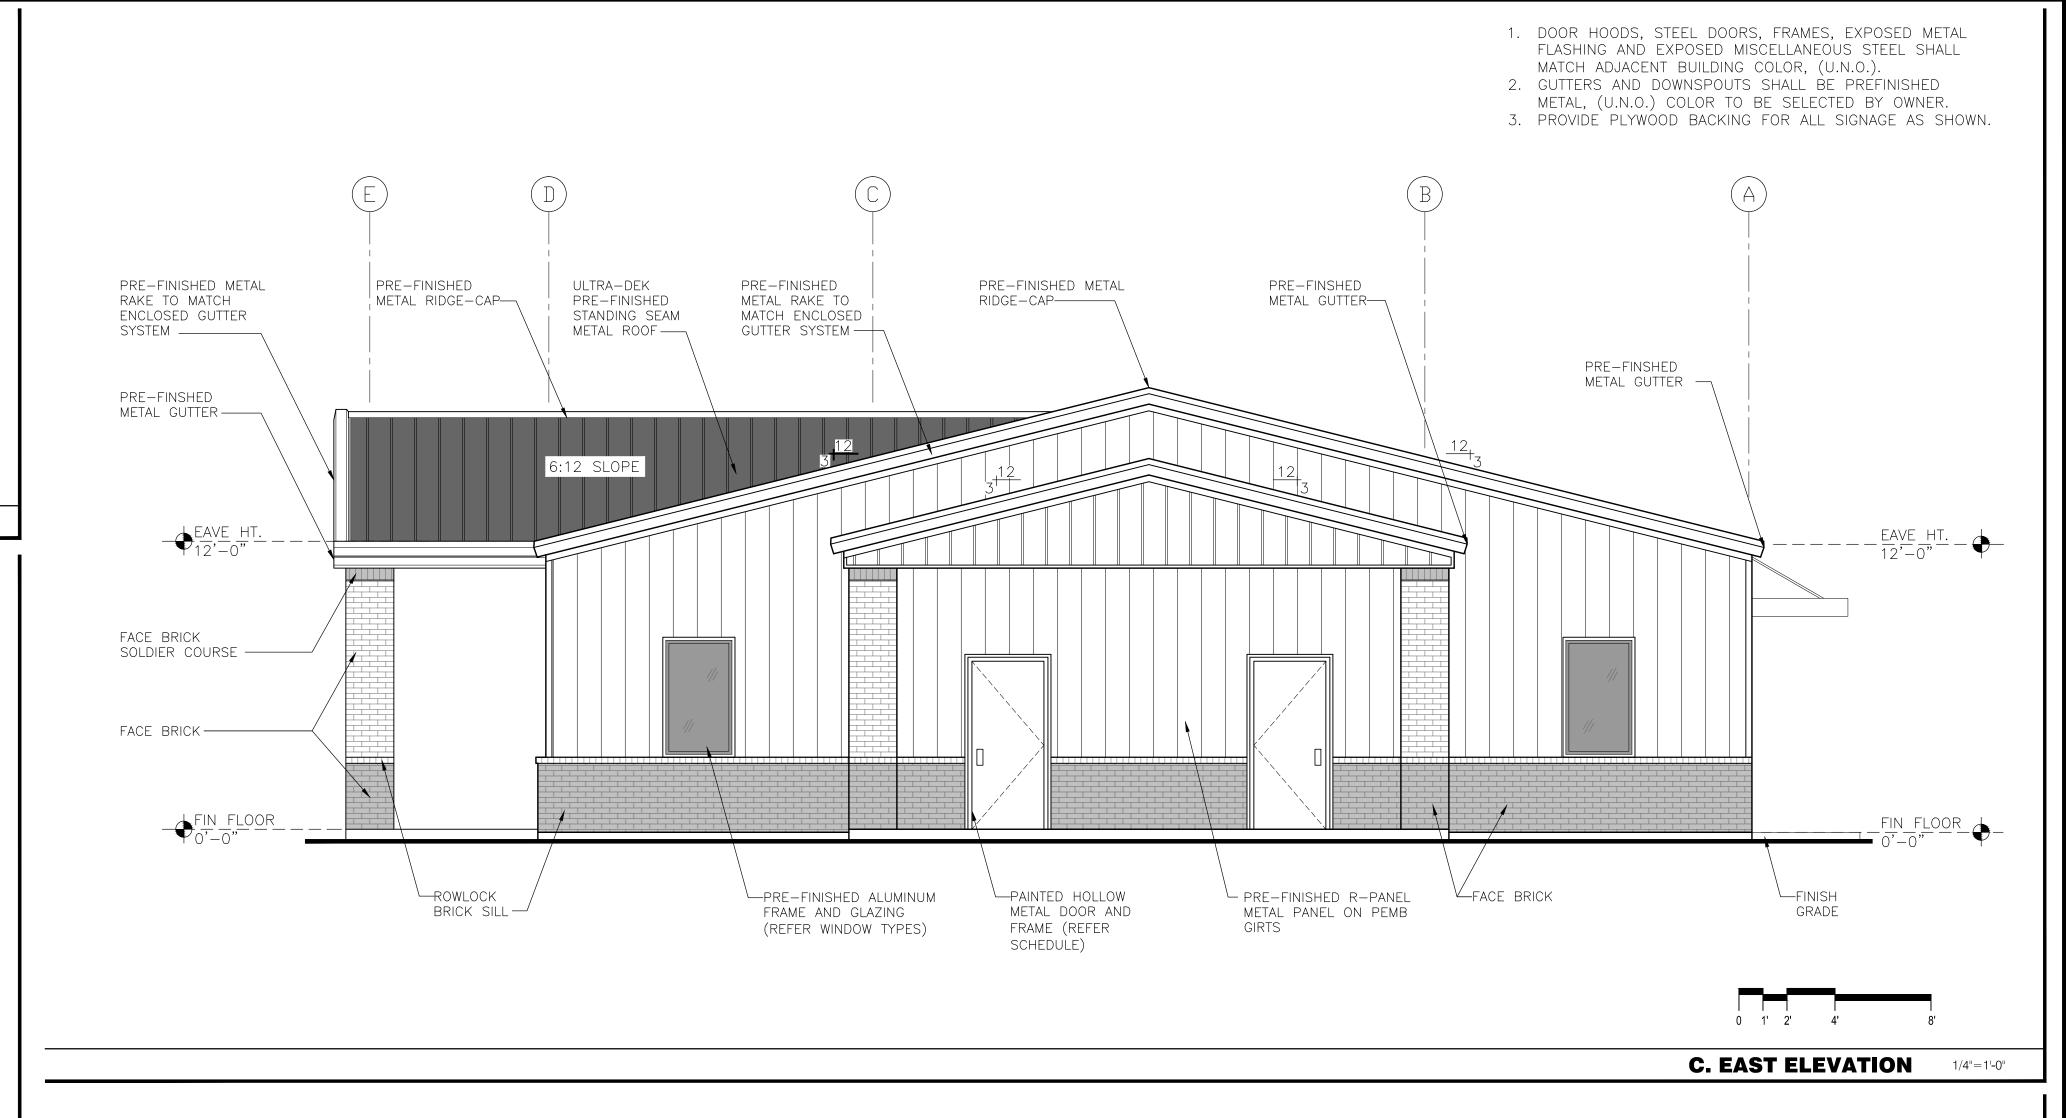
Job Number: 050-21003


- 1. FILL ALL CELLS BELOW FLOOR LEVEL OR CONTAINING REBAR WITH 2500 PSI GROUT. GROUT SHALL BE PLACED IN LIFTS NO HIGHER THAN 5 FEET. MASONRY UNITS SHALL BE CLEAN AND DRY. INSTALL ALL TIES AND STRAPS PER MANUFACTURER'S SPECIFICATIONS.
- 2. ALL MASONRY SHALL BE PLACED IN FULL MORTAR BED. ALL MORTAR SHALL BE TYPE "M" OR TYPE "S."
- 3. THE INTERSECTION OF ALL MASONRY WALLS SHALL BE TIED WITH A 1¼" X ¼" BY 30" LONG STRAP WITH A 3" 90 DEGREE BEND AT EACH END. STEEL STRAPS SHALL BE PLACED IN THE MORTAR BEDS AT 48" ON CENTER VERTICALLY.
- 4. THE CONTRACTOR SHALL TAKE ADDITIONAL PRECAUTIONS WHEN MASONRY IS TO BE CONSTRUCTED DURING COLD WEATHER (AMBIENT TEMPERATURE BELOW 40 DEGREES FAHRENHEIT). DURING HOT CONDITIONS (ABOVE 90 DEGREES FAHRENHEIT) PRECAUTIONS SHALL BE TAKEN TO MINIMIZE EXCESS HEAT IN THE MASONRY UNITS CONCERNING WATER AND MORTAR. IT IS ADVISED THAT THE CONTRACTOR FOLLOW RECOMMENDATIONS PRESCRIBED BY THE PORTLAND CEMENT ASSOCIATION FOR COLD AND HOT WEATHER CONDITIONS.
- 5. ALL CONTROL JOINTS AND EXPANSION JOINTS SHALL BE INSTALLED IN ACCORDANCE TO THE STANDARDS SET FORTH BY THE NATIONAL CONCRETE MASONRY ASSOCIATION. IN NO CASE SHALL EXTERIOR WALL JOINTS BE SPACED GREATER THAN 30' ON CENTER AND INTERIOR WALL JOINTS SHALL NOT EXCEED 30' ON CENTER.
- 6. BRICK VENEER SIZE AND COLOR, AND MORTOR COLOR, TO MATCH EXISTING SCHOOL BUILDING AS CLOSE AS POSSIBLE.
- 7. WHERE NOTED, ON VENEER WALLS, PROVIDE $\frac{3}{8}$ " $-\frac{1}{2}$ " CONTROL JOINTS BACKED WITH FOAM BACKER RODS, AND SEALED WITH NP1 OR EQUAL, COLOR TO MATCH BRICK COLOR.
- 8. ATTENTION SHALL BE GIVEN TO PROVIDE FULL HEAD AND BED JOINTS AND CLEAN CAVITY.
- 9. PROVIDE VENEER ANCHORS @ 16" ON CENTER VERTICALLY, 32" ON CENTER HORIZONTALLY. (PER IBC 2015)
- 10. PROVIDE 10 MIL. PVC FLASHING WITH WEEPS AT APPROXIMATELY 32" ON CENTER MAXIMUM.

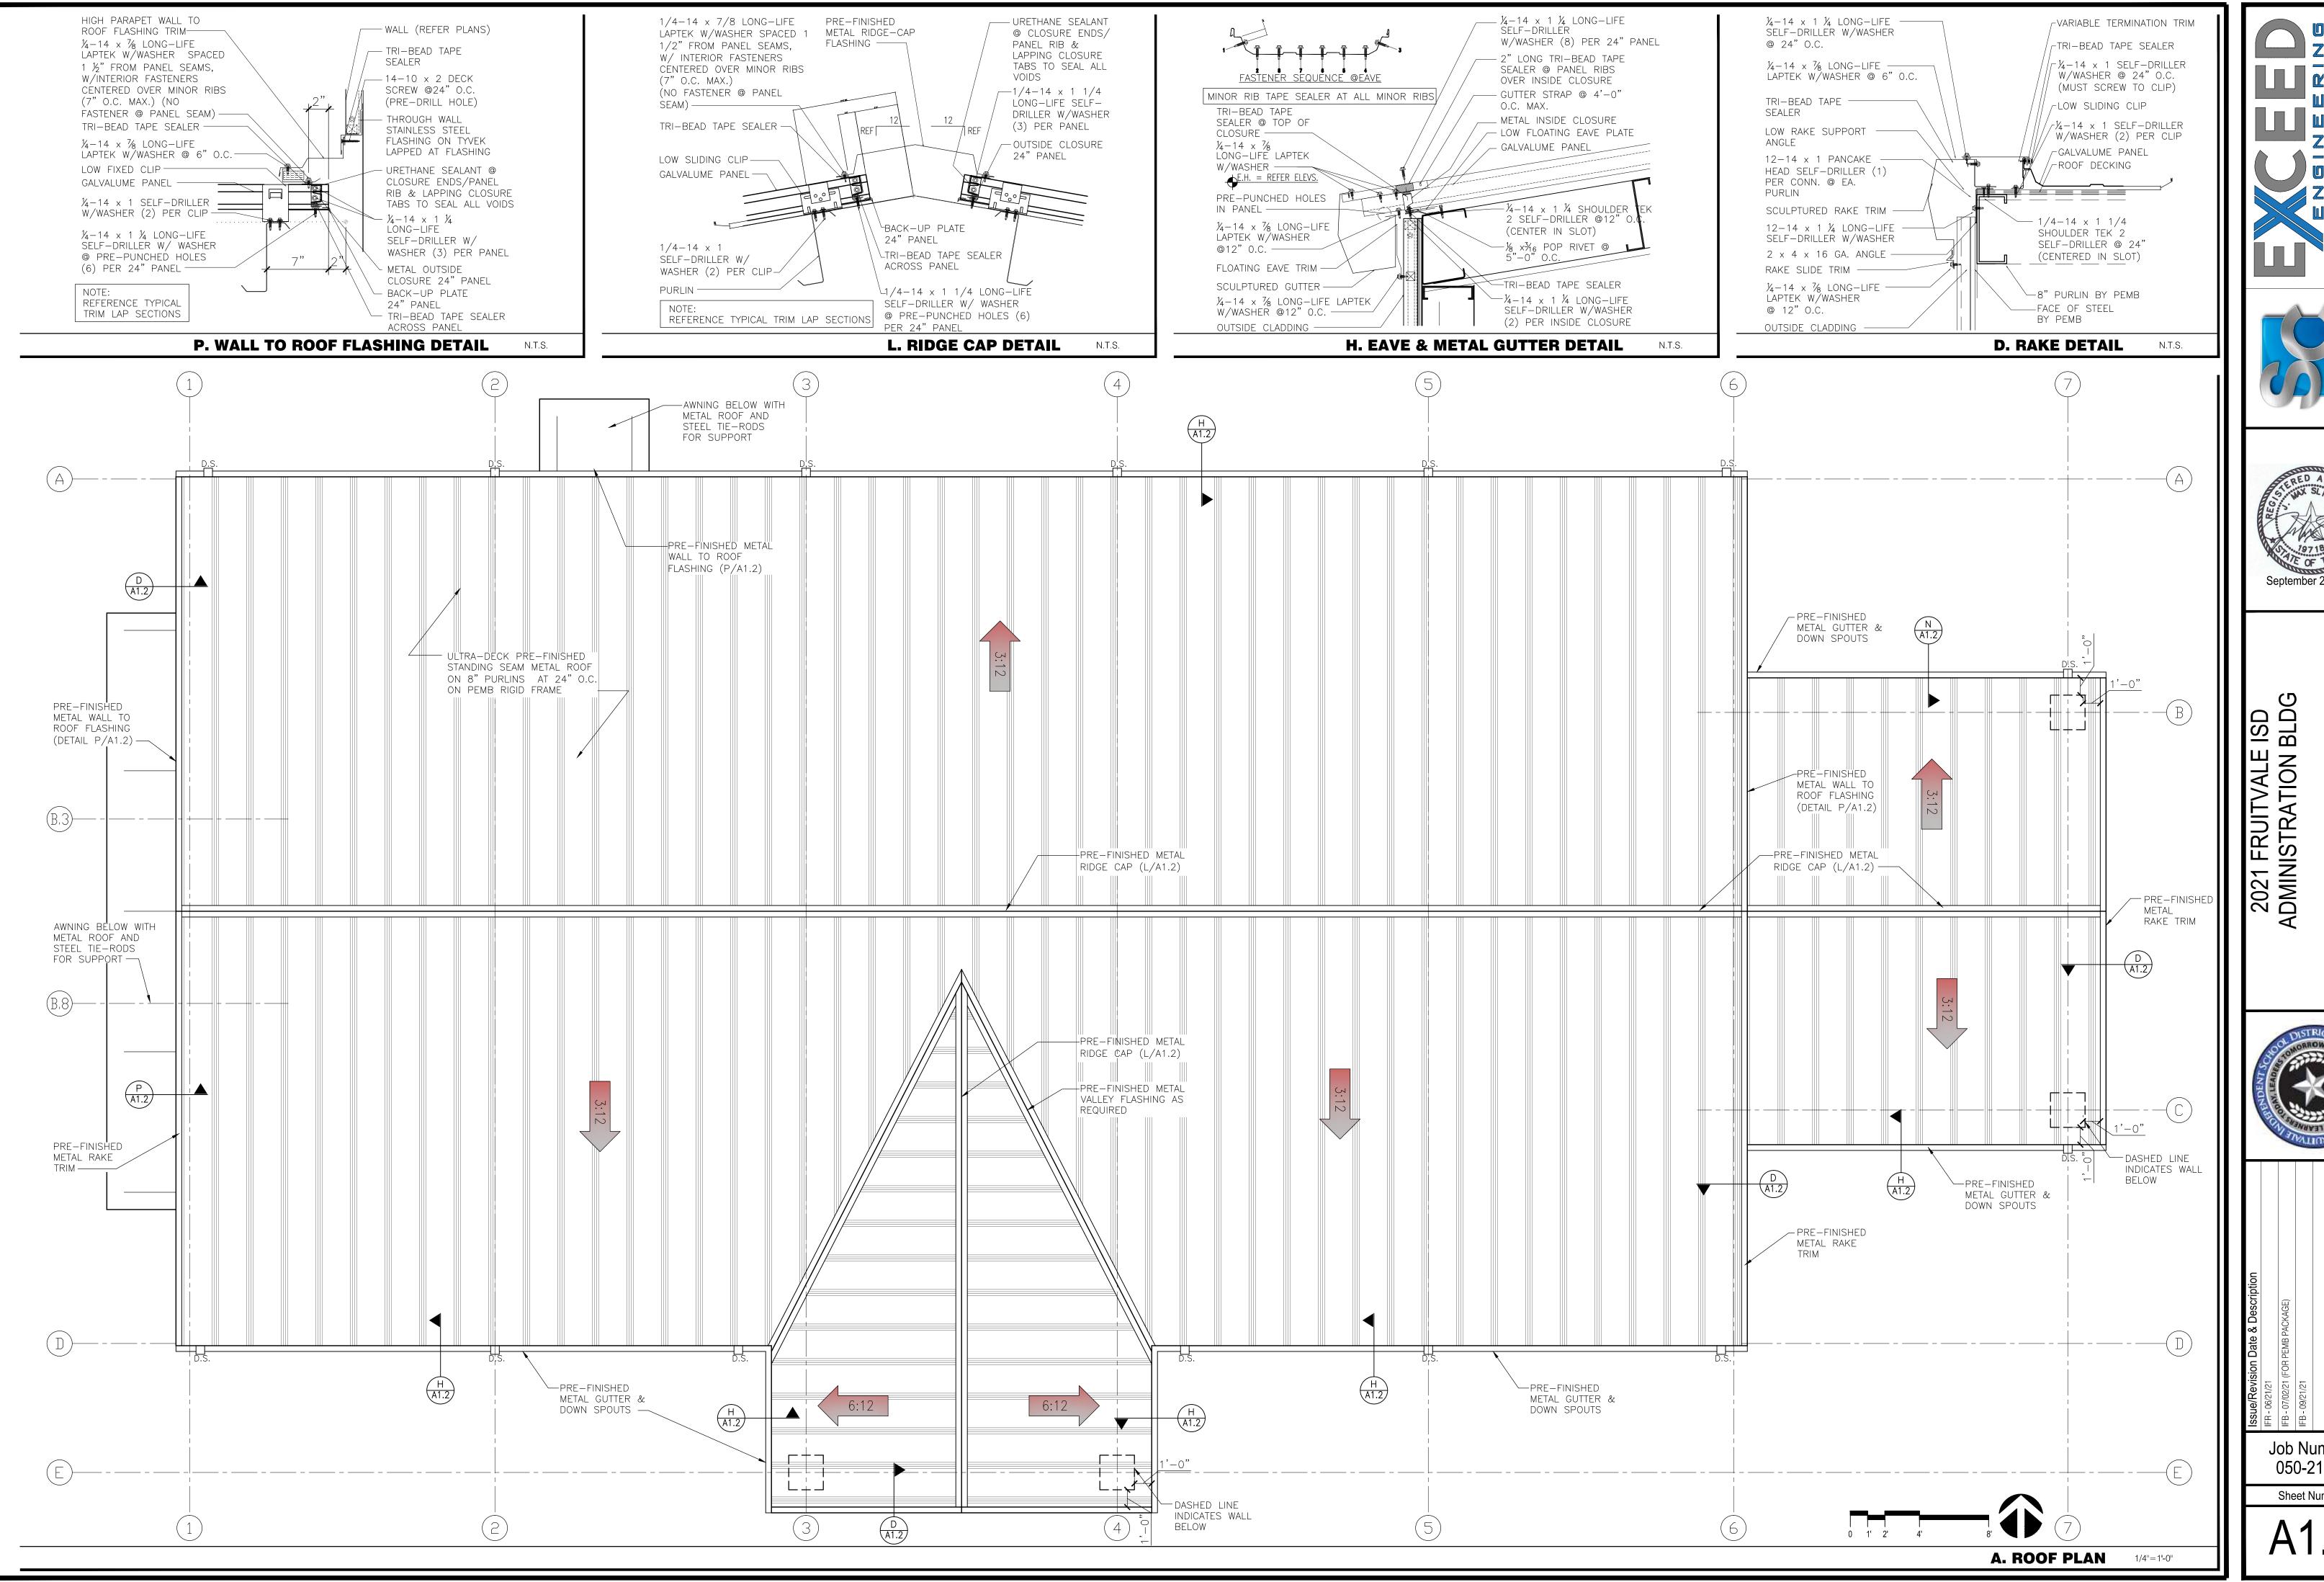
P. MASONRY NOTES NTS

PRE-FINISHED ULTRA DEK METAL ROOF PANELS ON 8" "Z" PURLINS — R-11 CONT. VINYL FACED BATT INSULATION OVER PURLINS BY P.E.M.B. R-19 VINYL FACED BATT INSULATION INSTALLED BETWEEN PURLINS WITH BANDING SYSTEM REFER TO | ELEVATIONS & - METAL EAVE STRUT ROOF PLAN _ 24 GA. PRE-FINISHED METAL GUTTER AND DOWN SPOUT (REFER H/A1.2) — CLOSURE AND ELEV: 12'-0" SEALANT AS TYPICAL CEILING HEIGHT - RIGID FRAME BEYOND - VINYL BACKED WALL INSULATION BY PEMB (R-11 MIN)--- CEILING AS SCHEDULED — 8" METAL WALL GIRT - BATT INSULATION — 26 GA. MULTI-RIBBED METAL WALL "R" PANEL _5/8" GYP.BD. ON 3%" METAL STUDS AT 16"O.C. TIE TO GIRT WITH METAL STRAPS (REFER GENERAL > FLASHING BY PEMB -\sloped brick water table METAL MASONRY WALL TIES PER I.B.C. _____26 GA. MULTI-RIBBED METAL WALL "R" PANEL /— CLOSURE AND SEALANT AS REQUIRED — 20 MIL. NERVASTROL CONTINUOUS FLASHING PROVIDE WEEP HOLES @ 32" O.C. SPLASH BLOCK - CONCRETE FOUNDATION (REFER STRUCTURAL) — BASE (AS SCHEDULED)

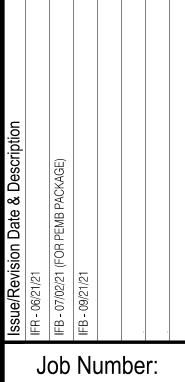
M. TYPICAL WALL SECTION AT WAINSCOT



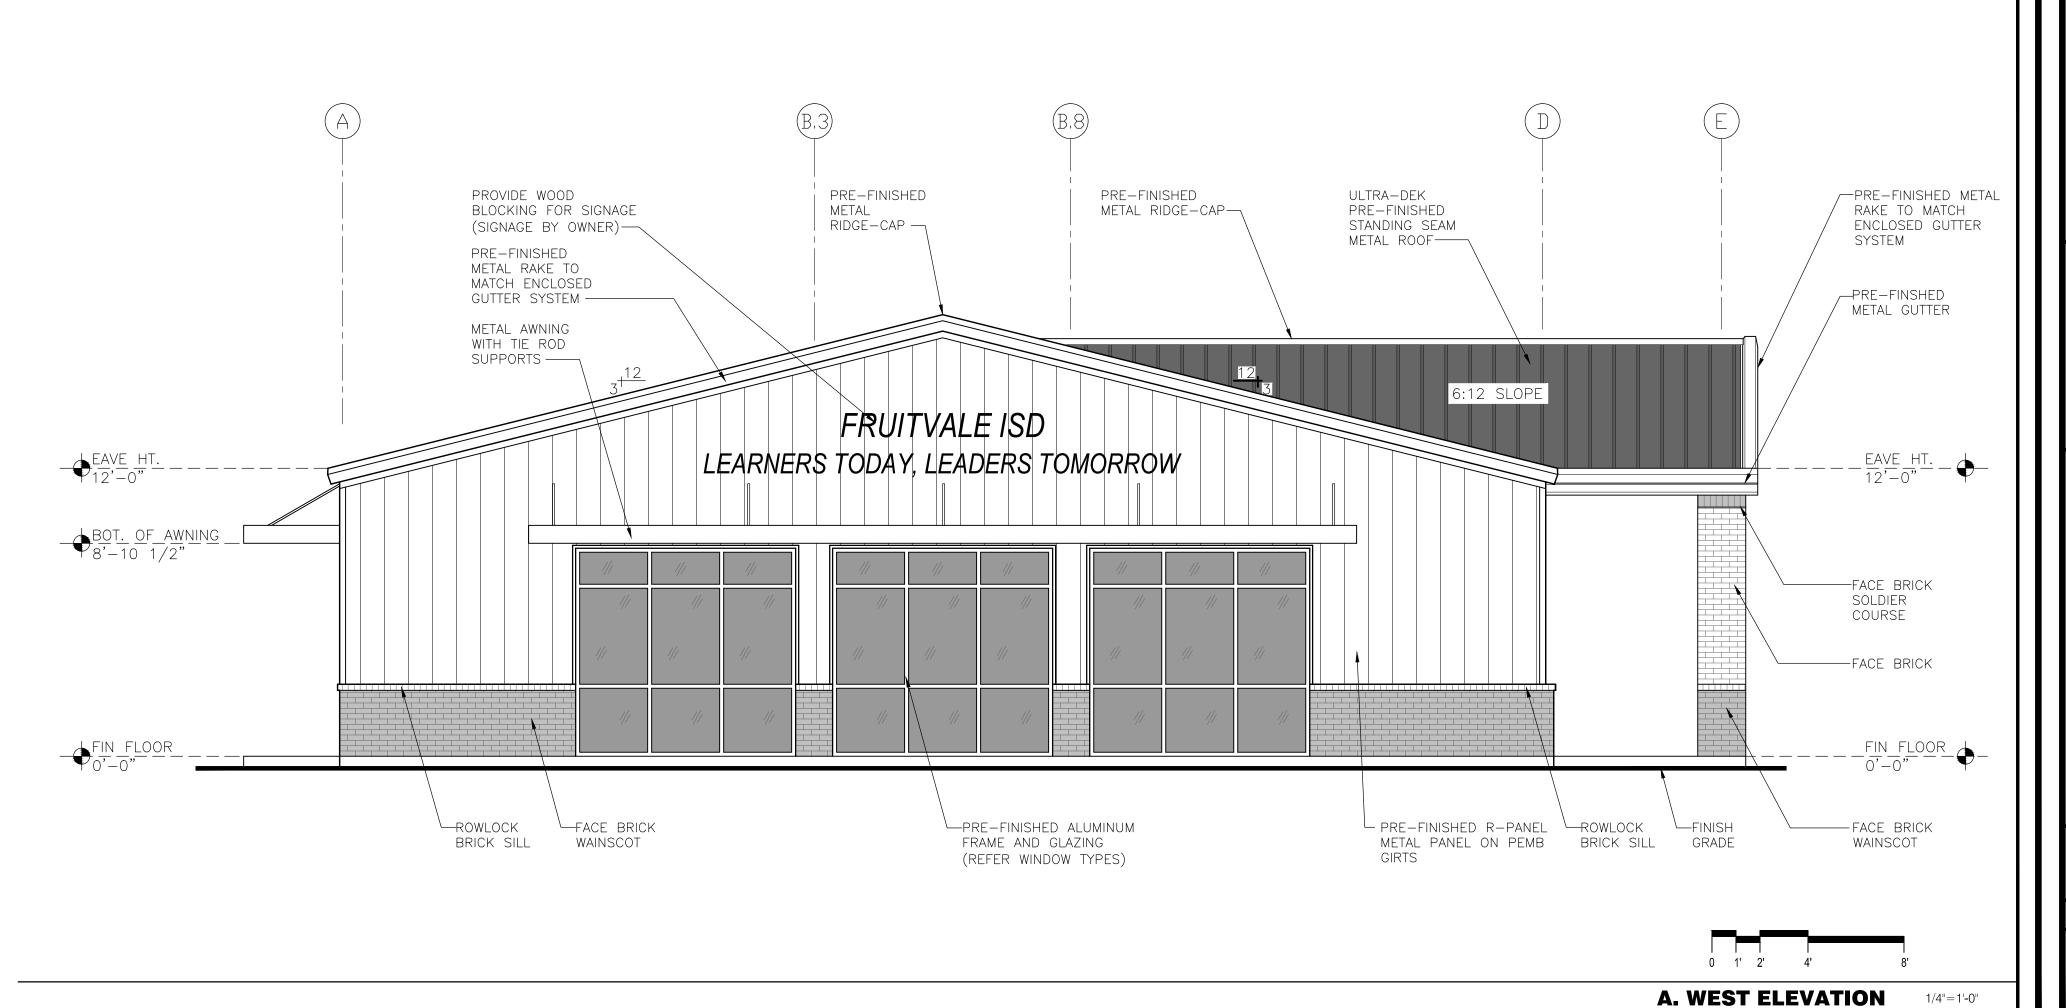

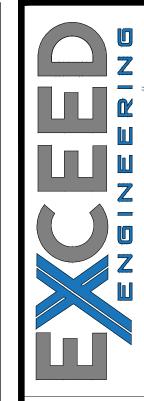




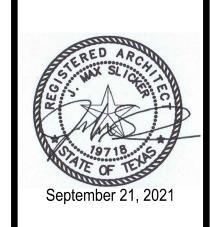

2021 FRUITVALE ISD
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FRUITVALE, TEXAS 75127
EXTERIOR ELEVATIONS


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ARCHITECTURE

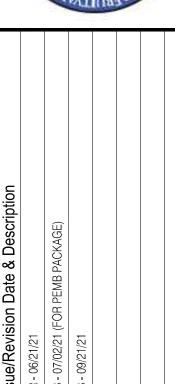September 21, 2021

2021 FRUITVALE ISD ADMINISTRATION BLDG FRUITVALE, TEXAS 75127 INTERIOR ELEVATIONS


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Job Number: 050-21003

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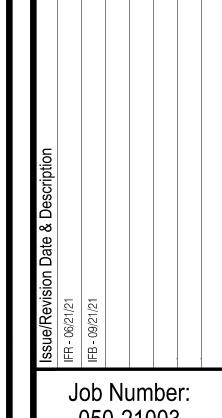
A2.2

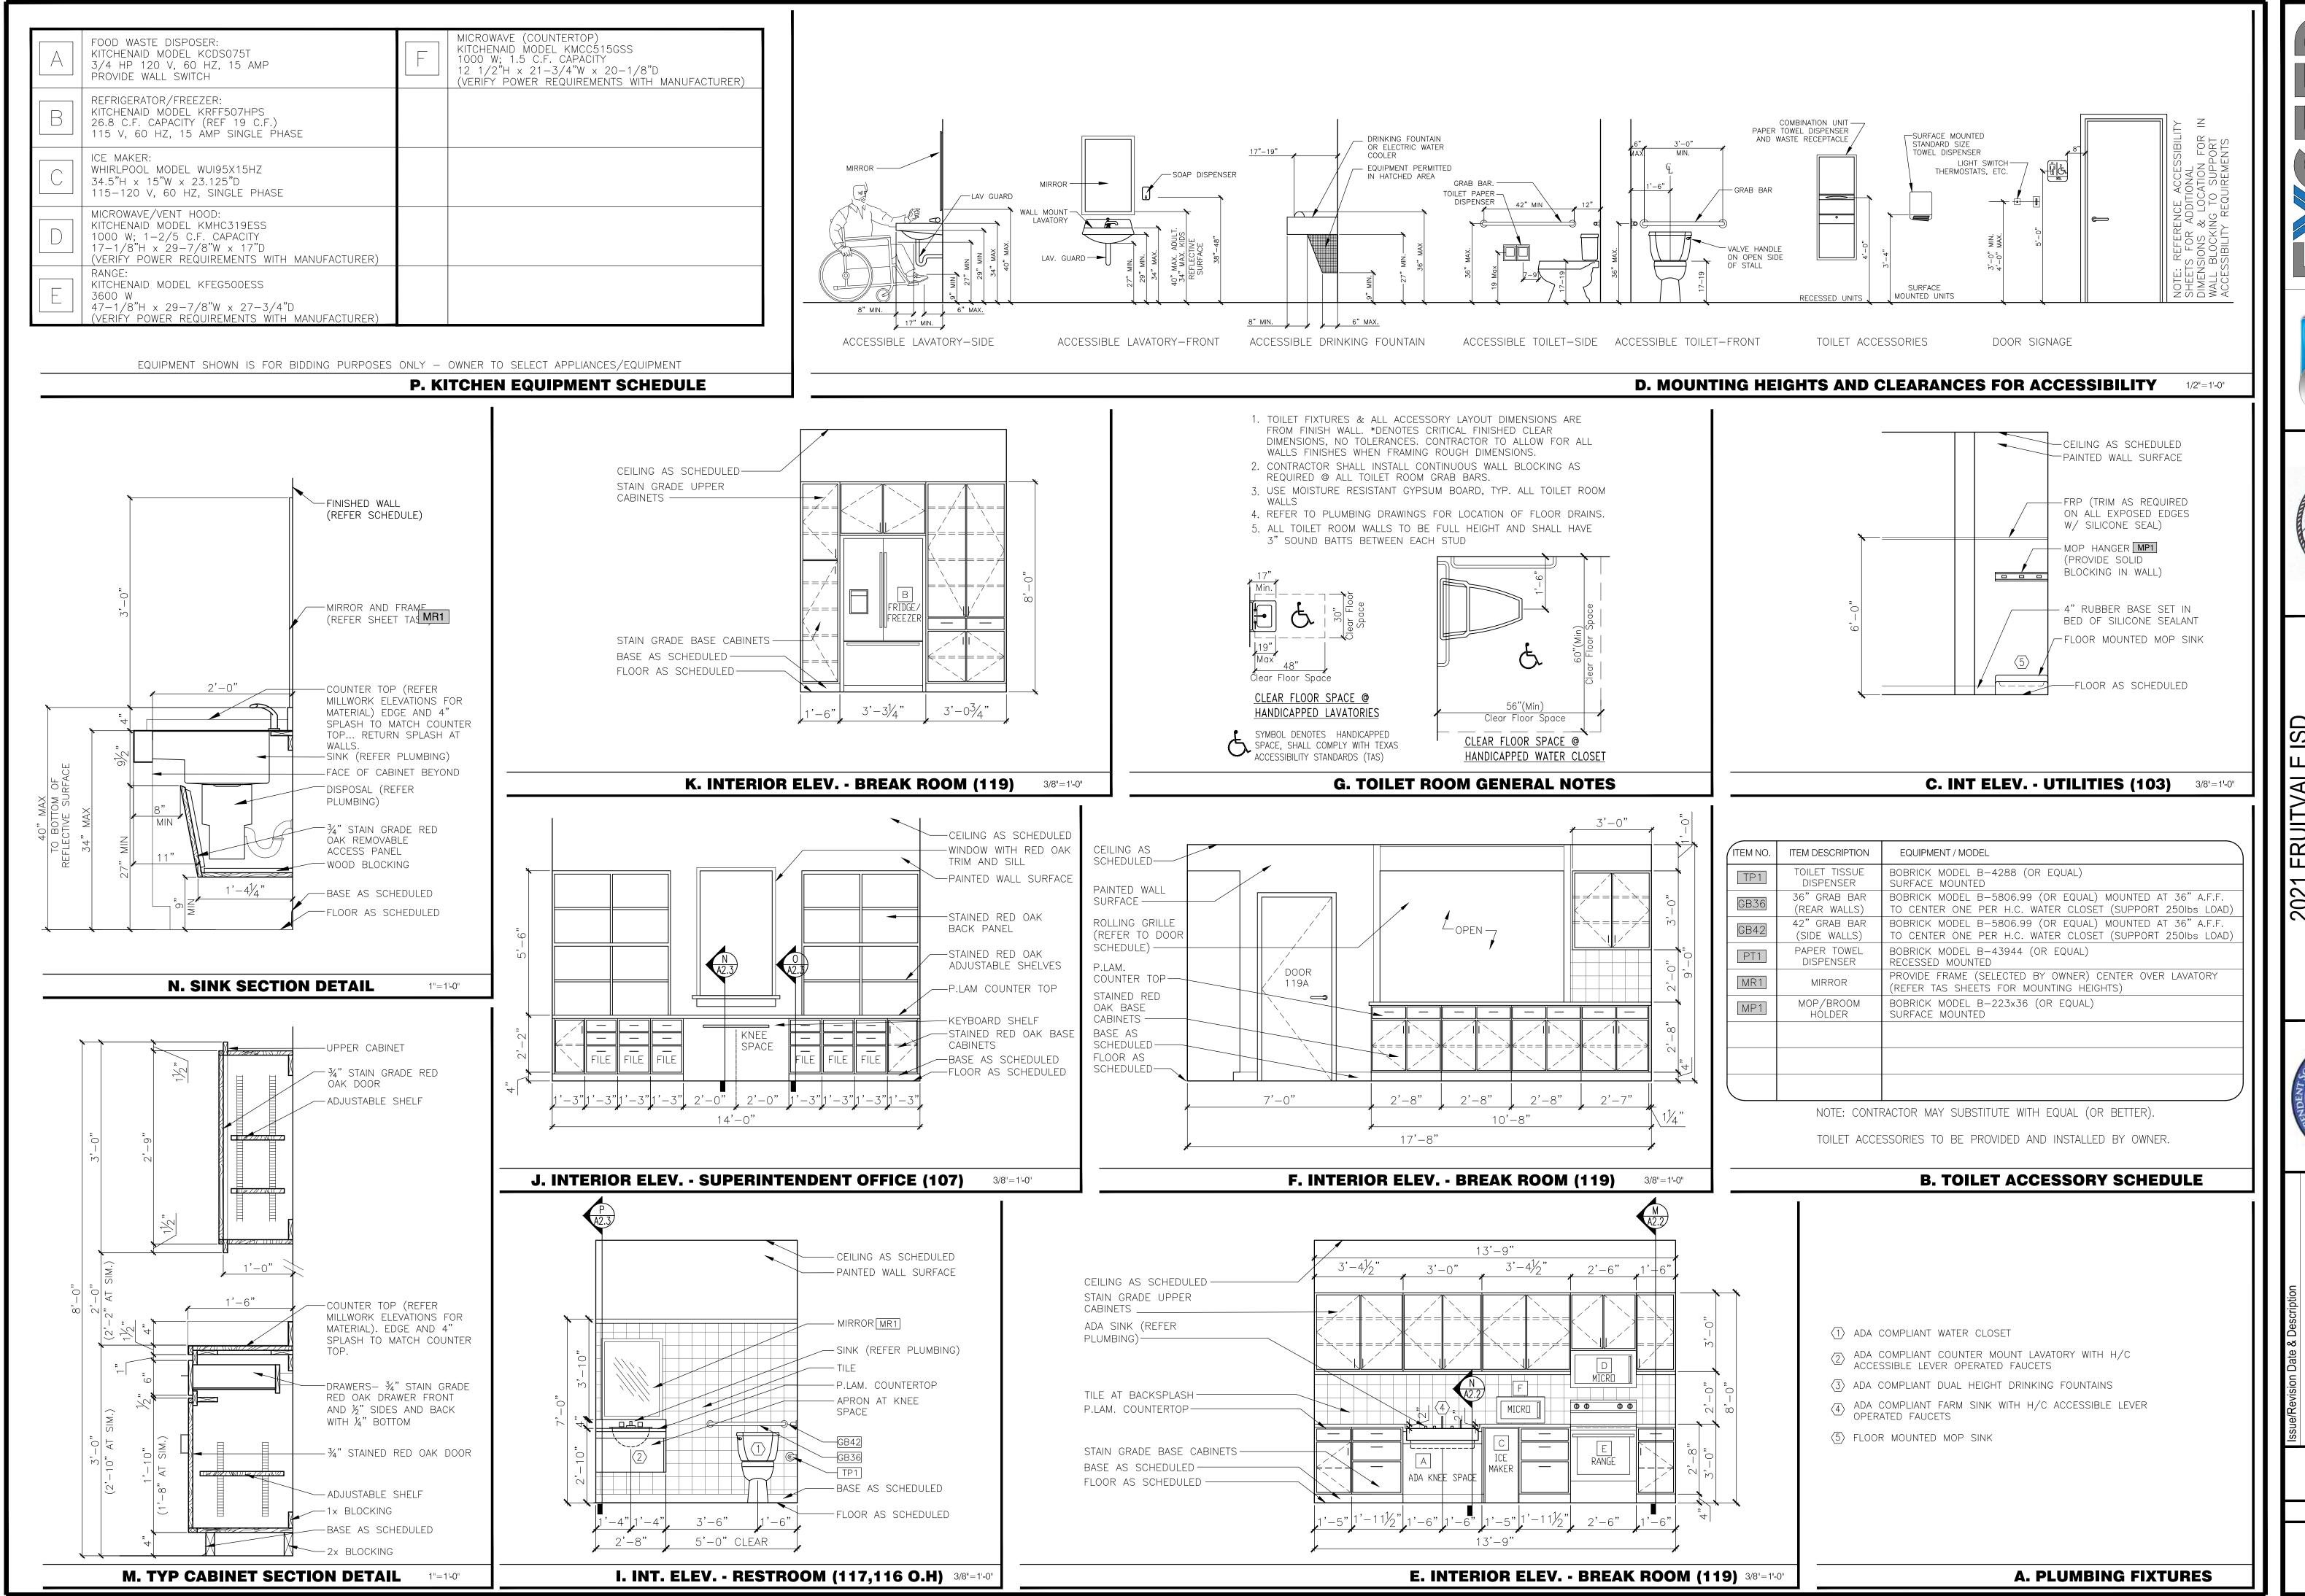







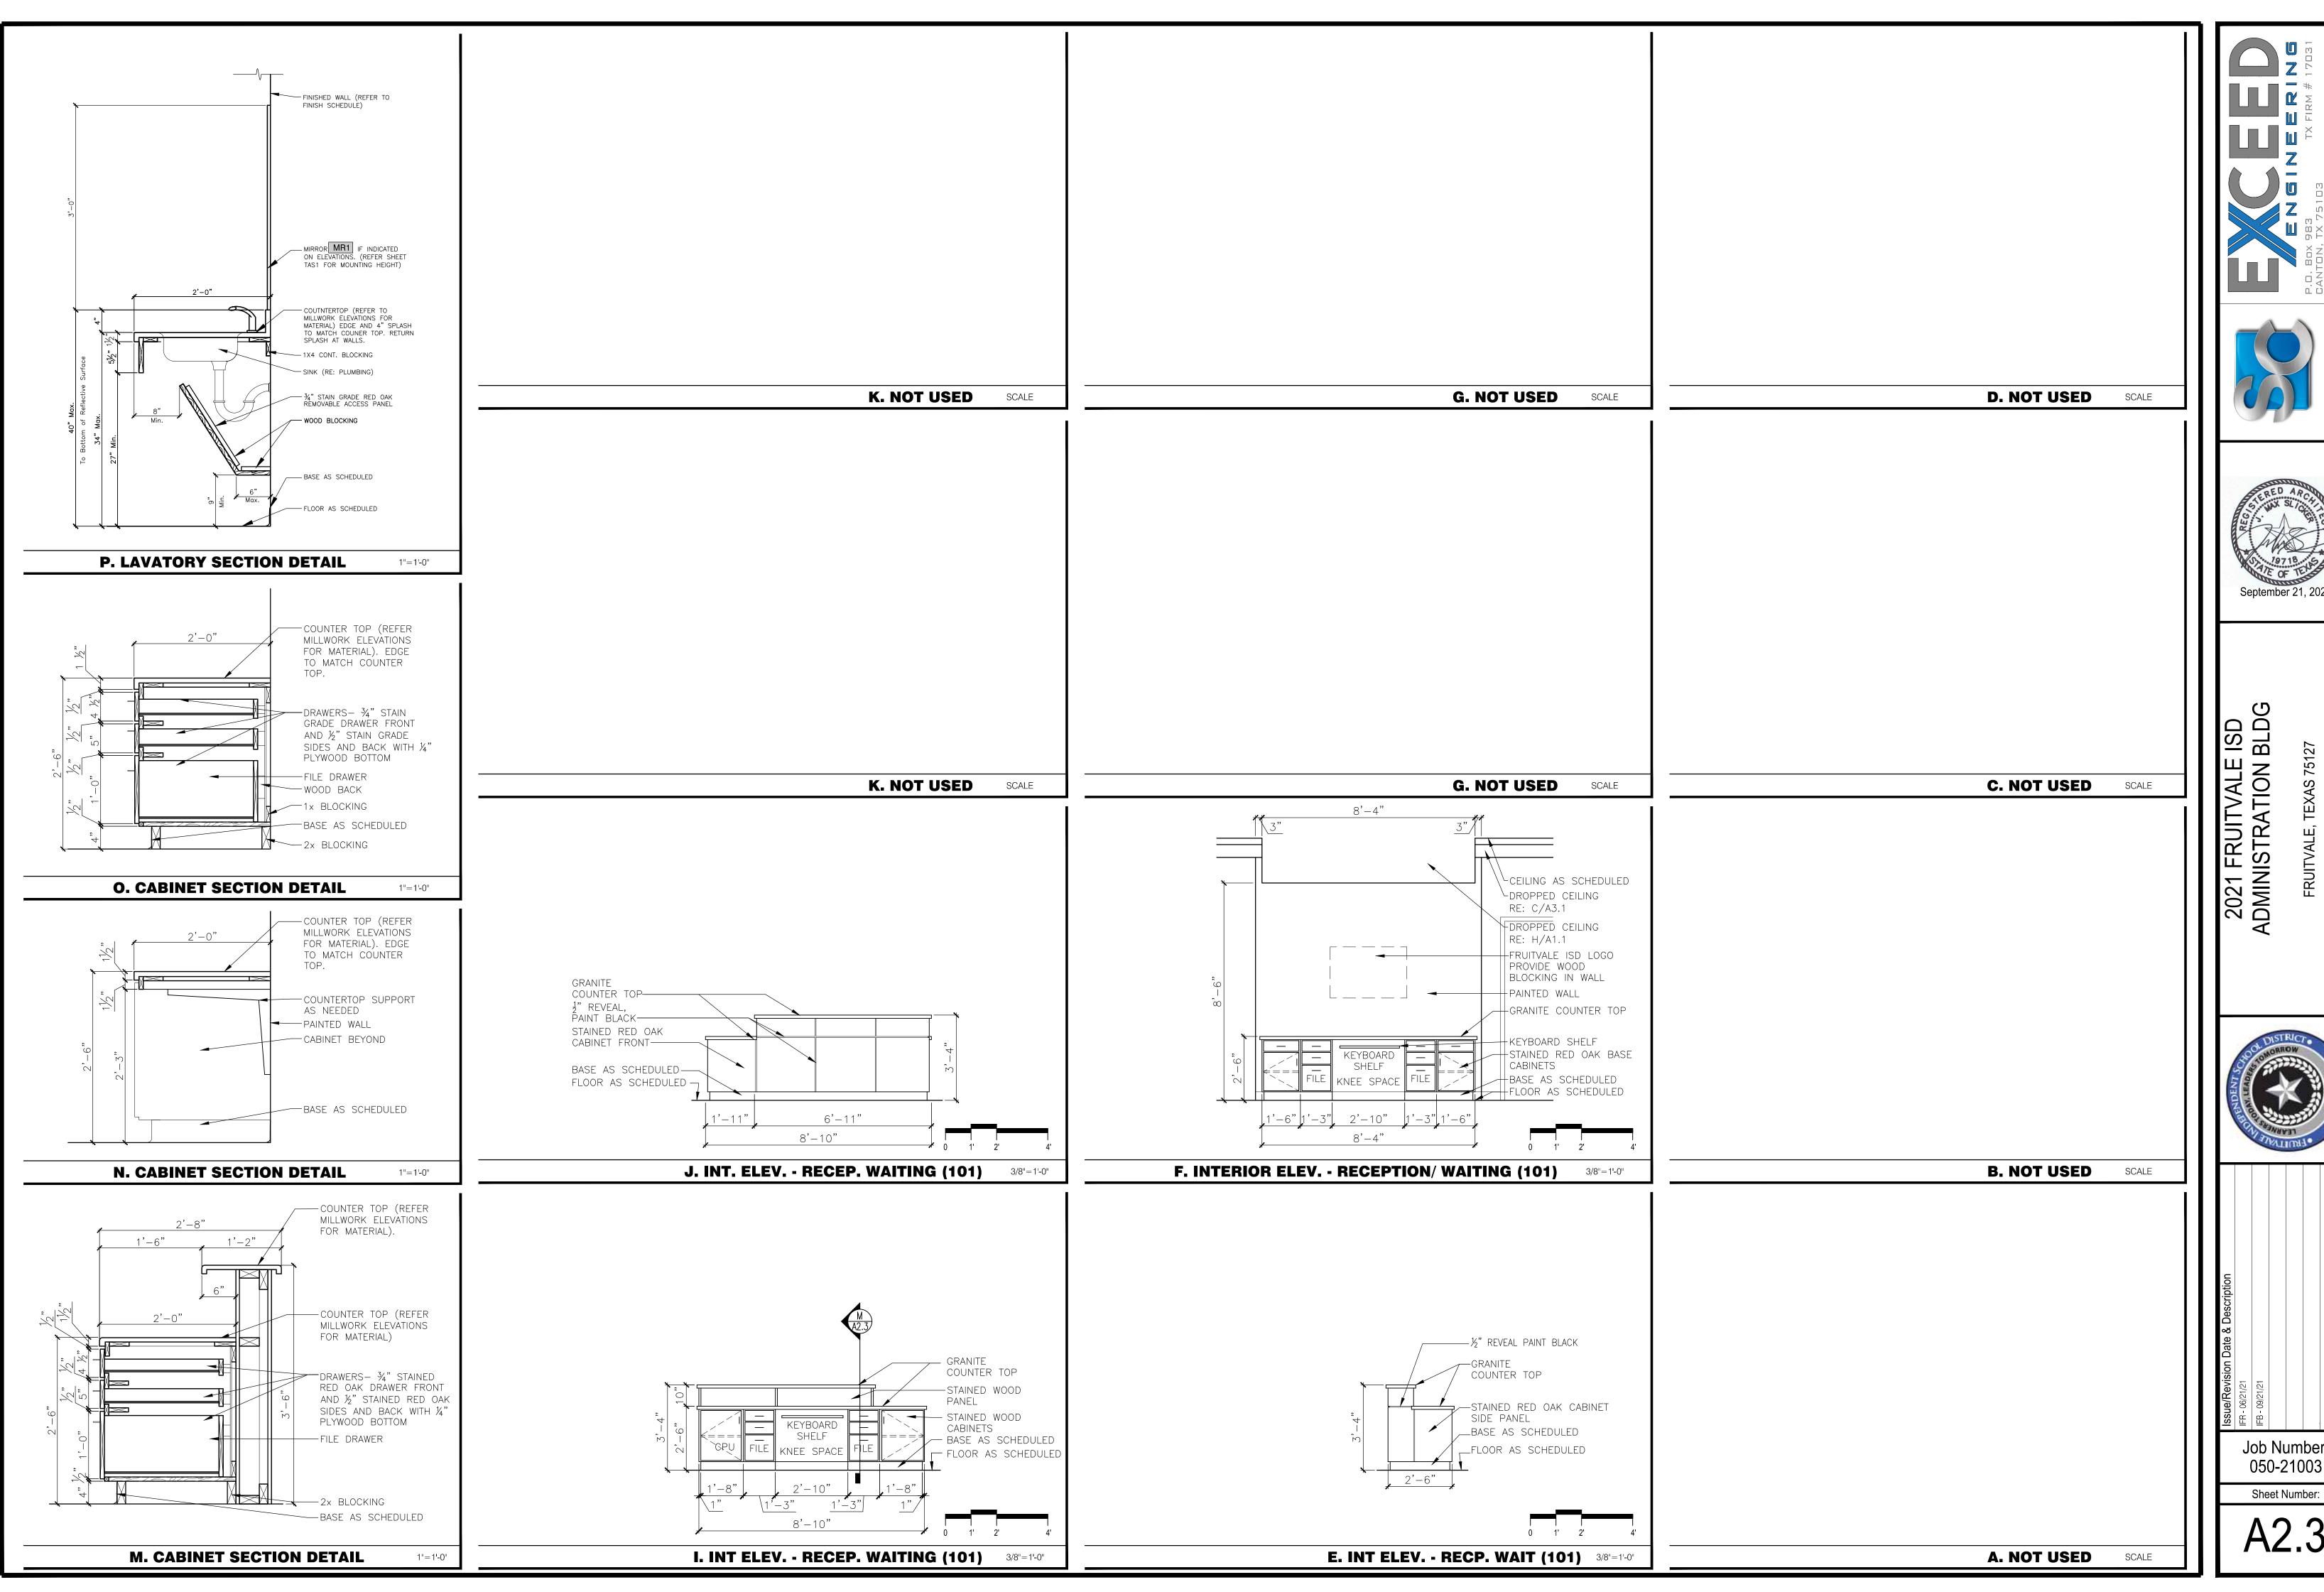



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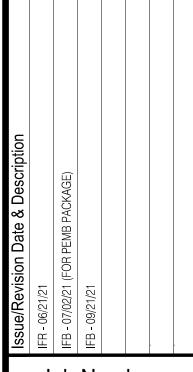


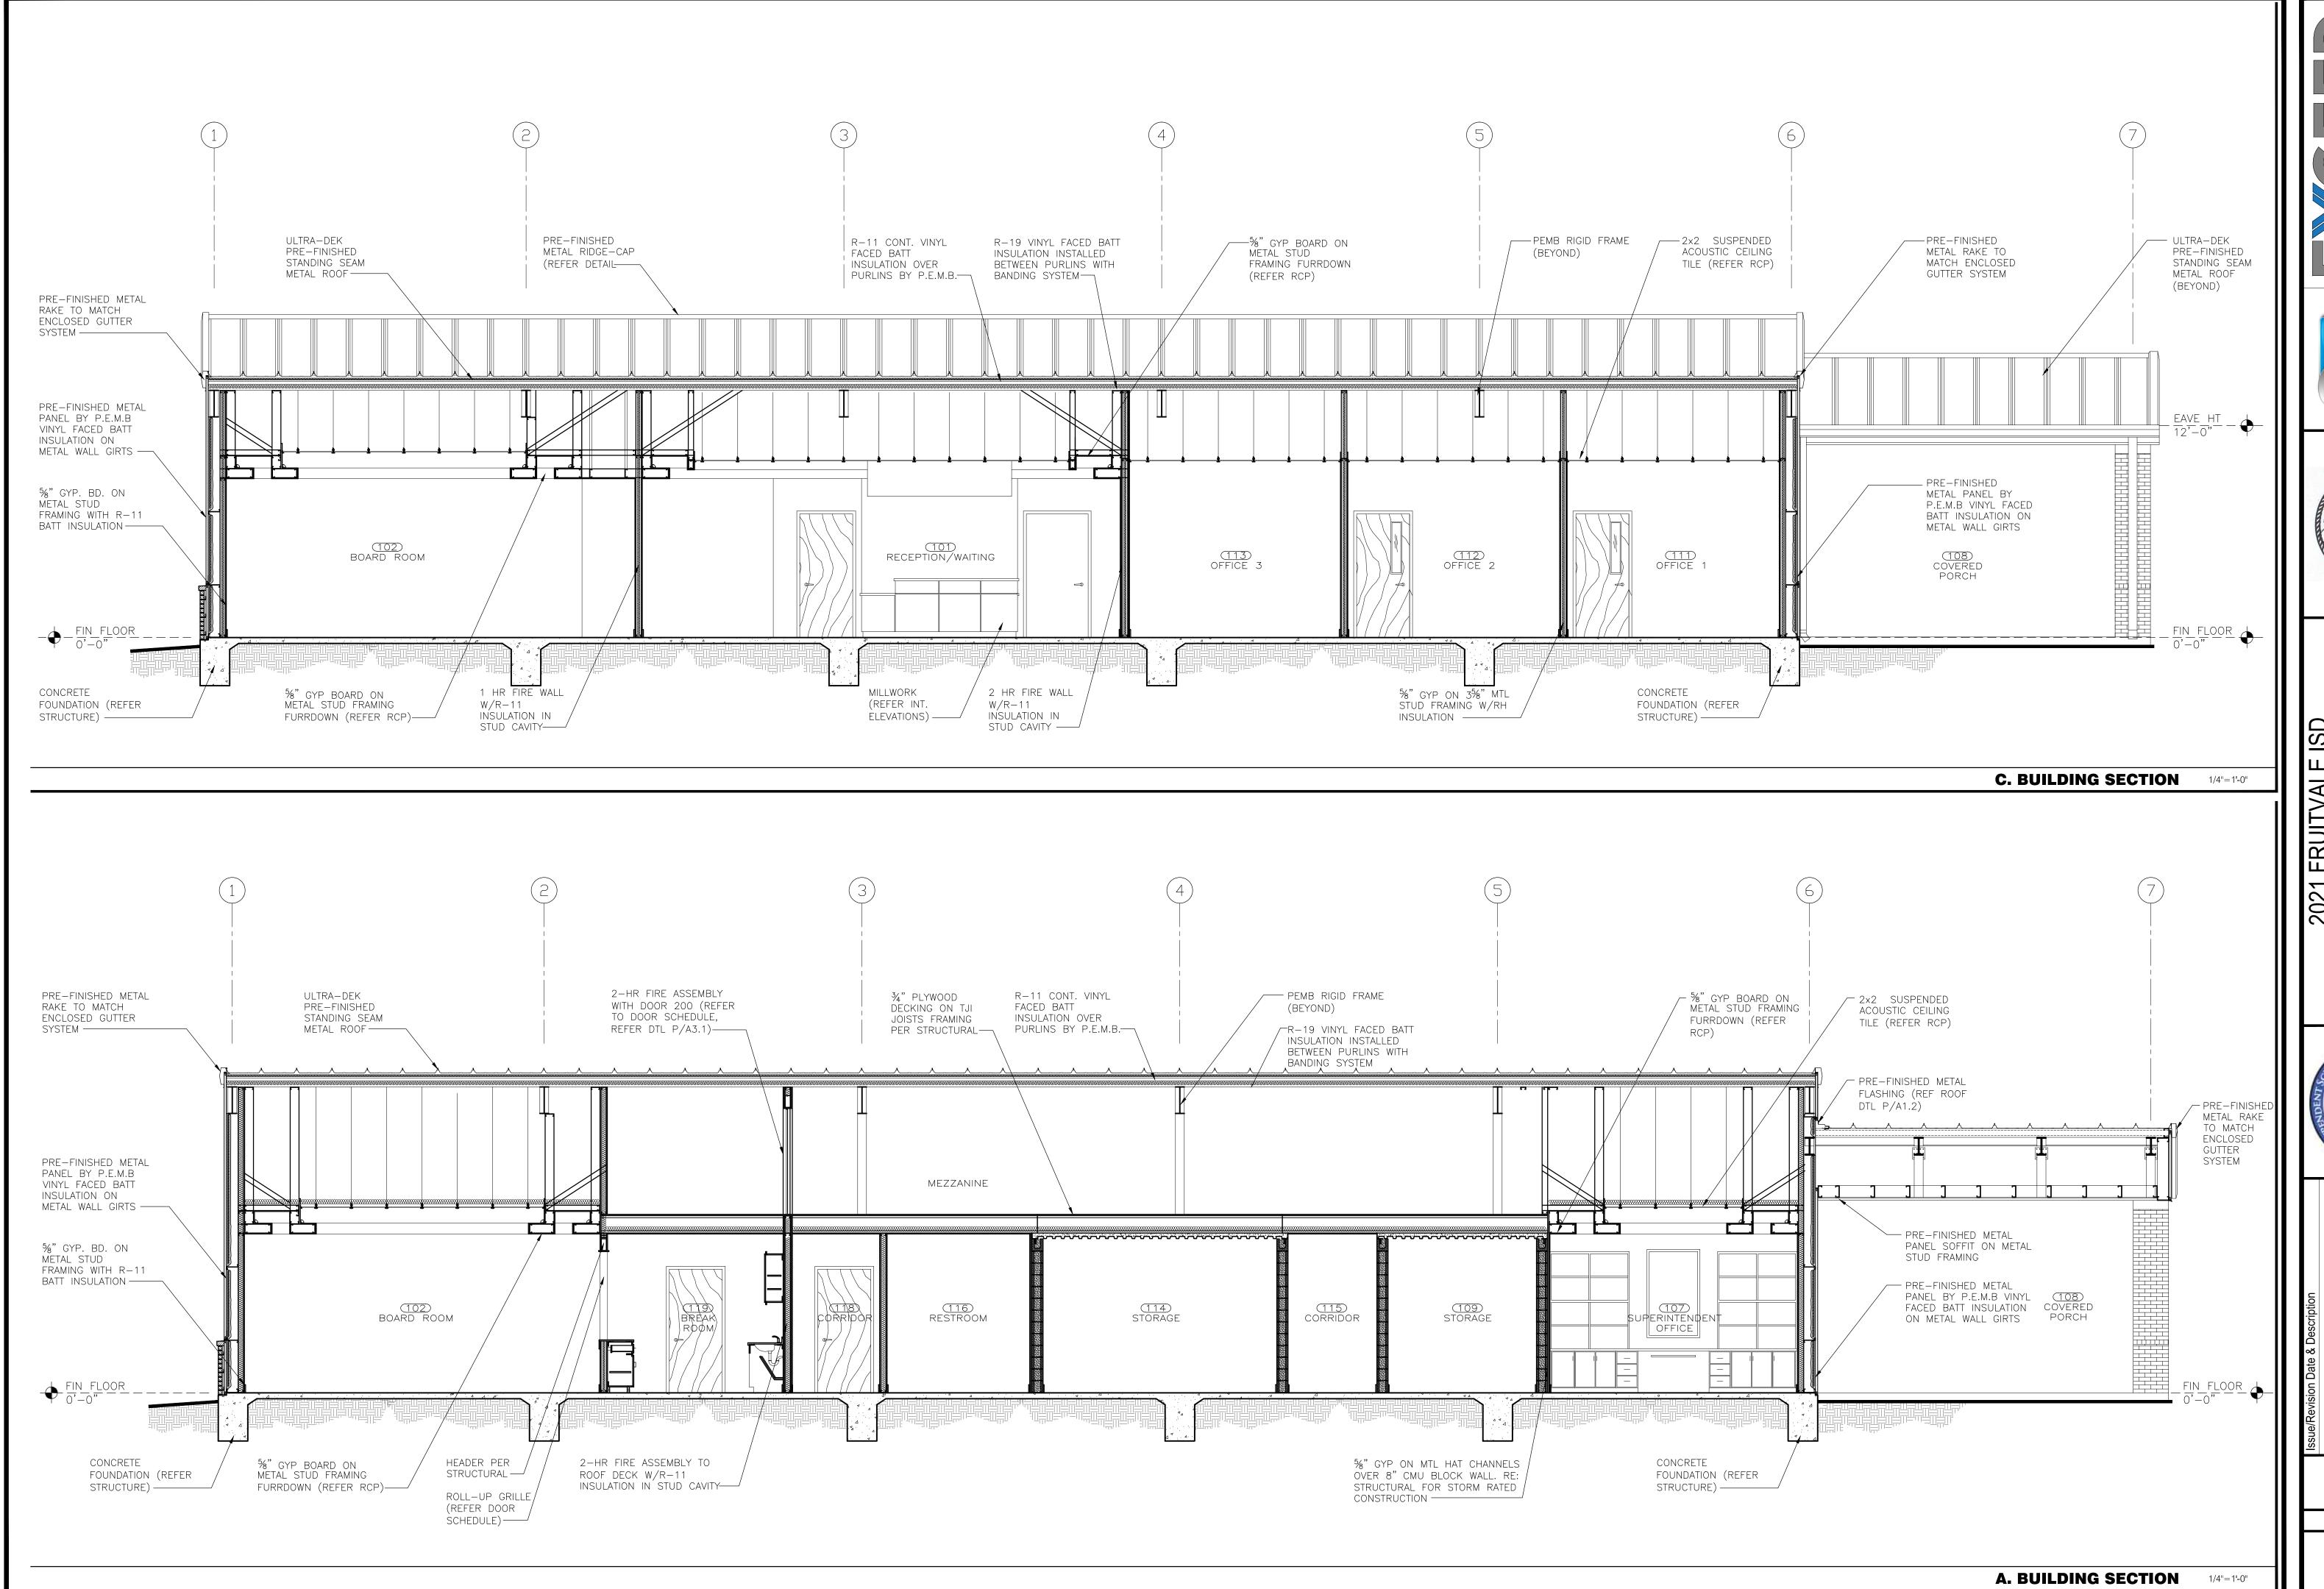

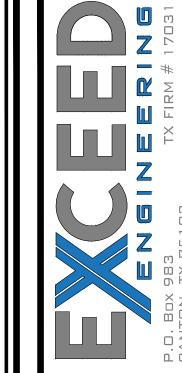

ADMINISTRATION BLDG






Job Number: 050-21003

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A3.0

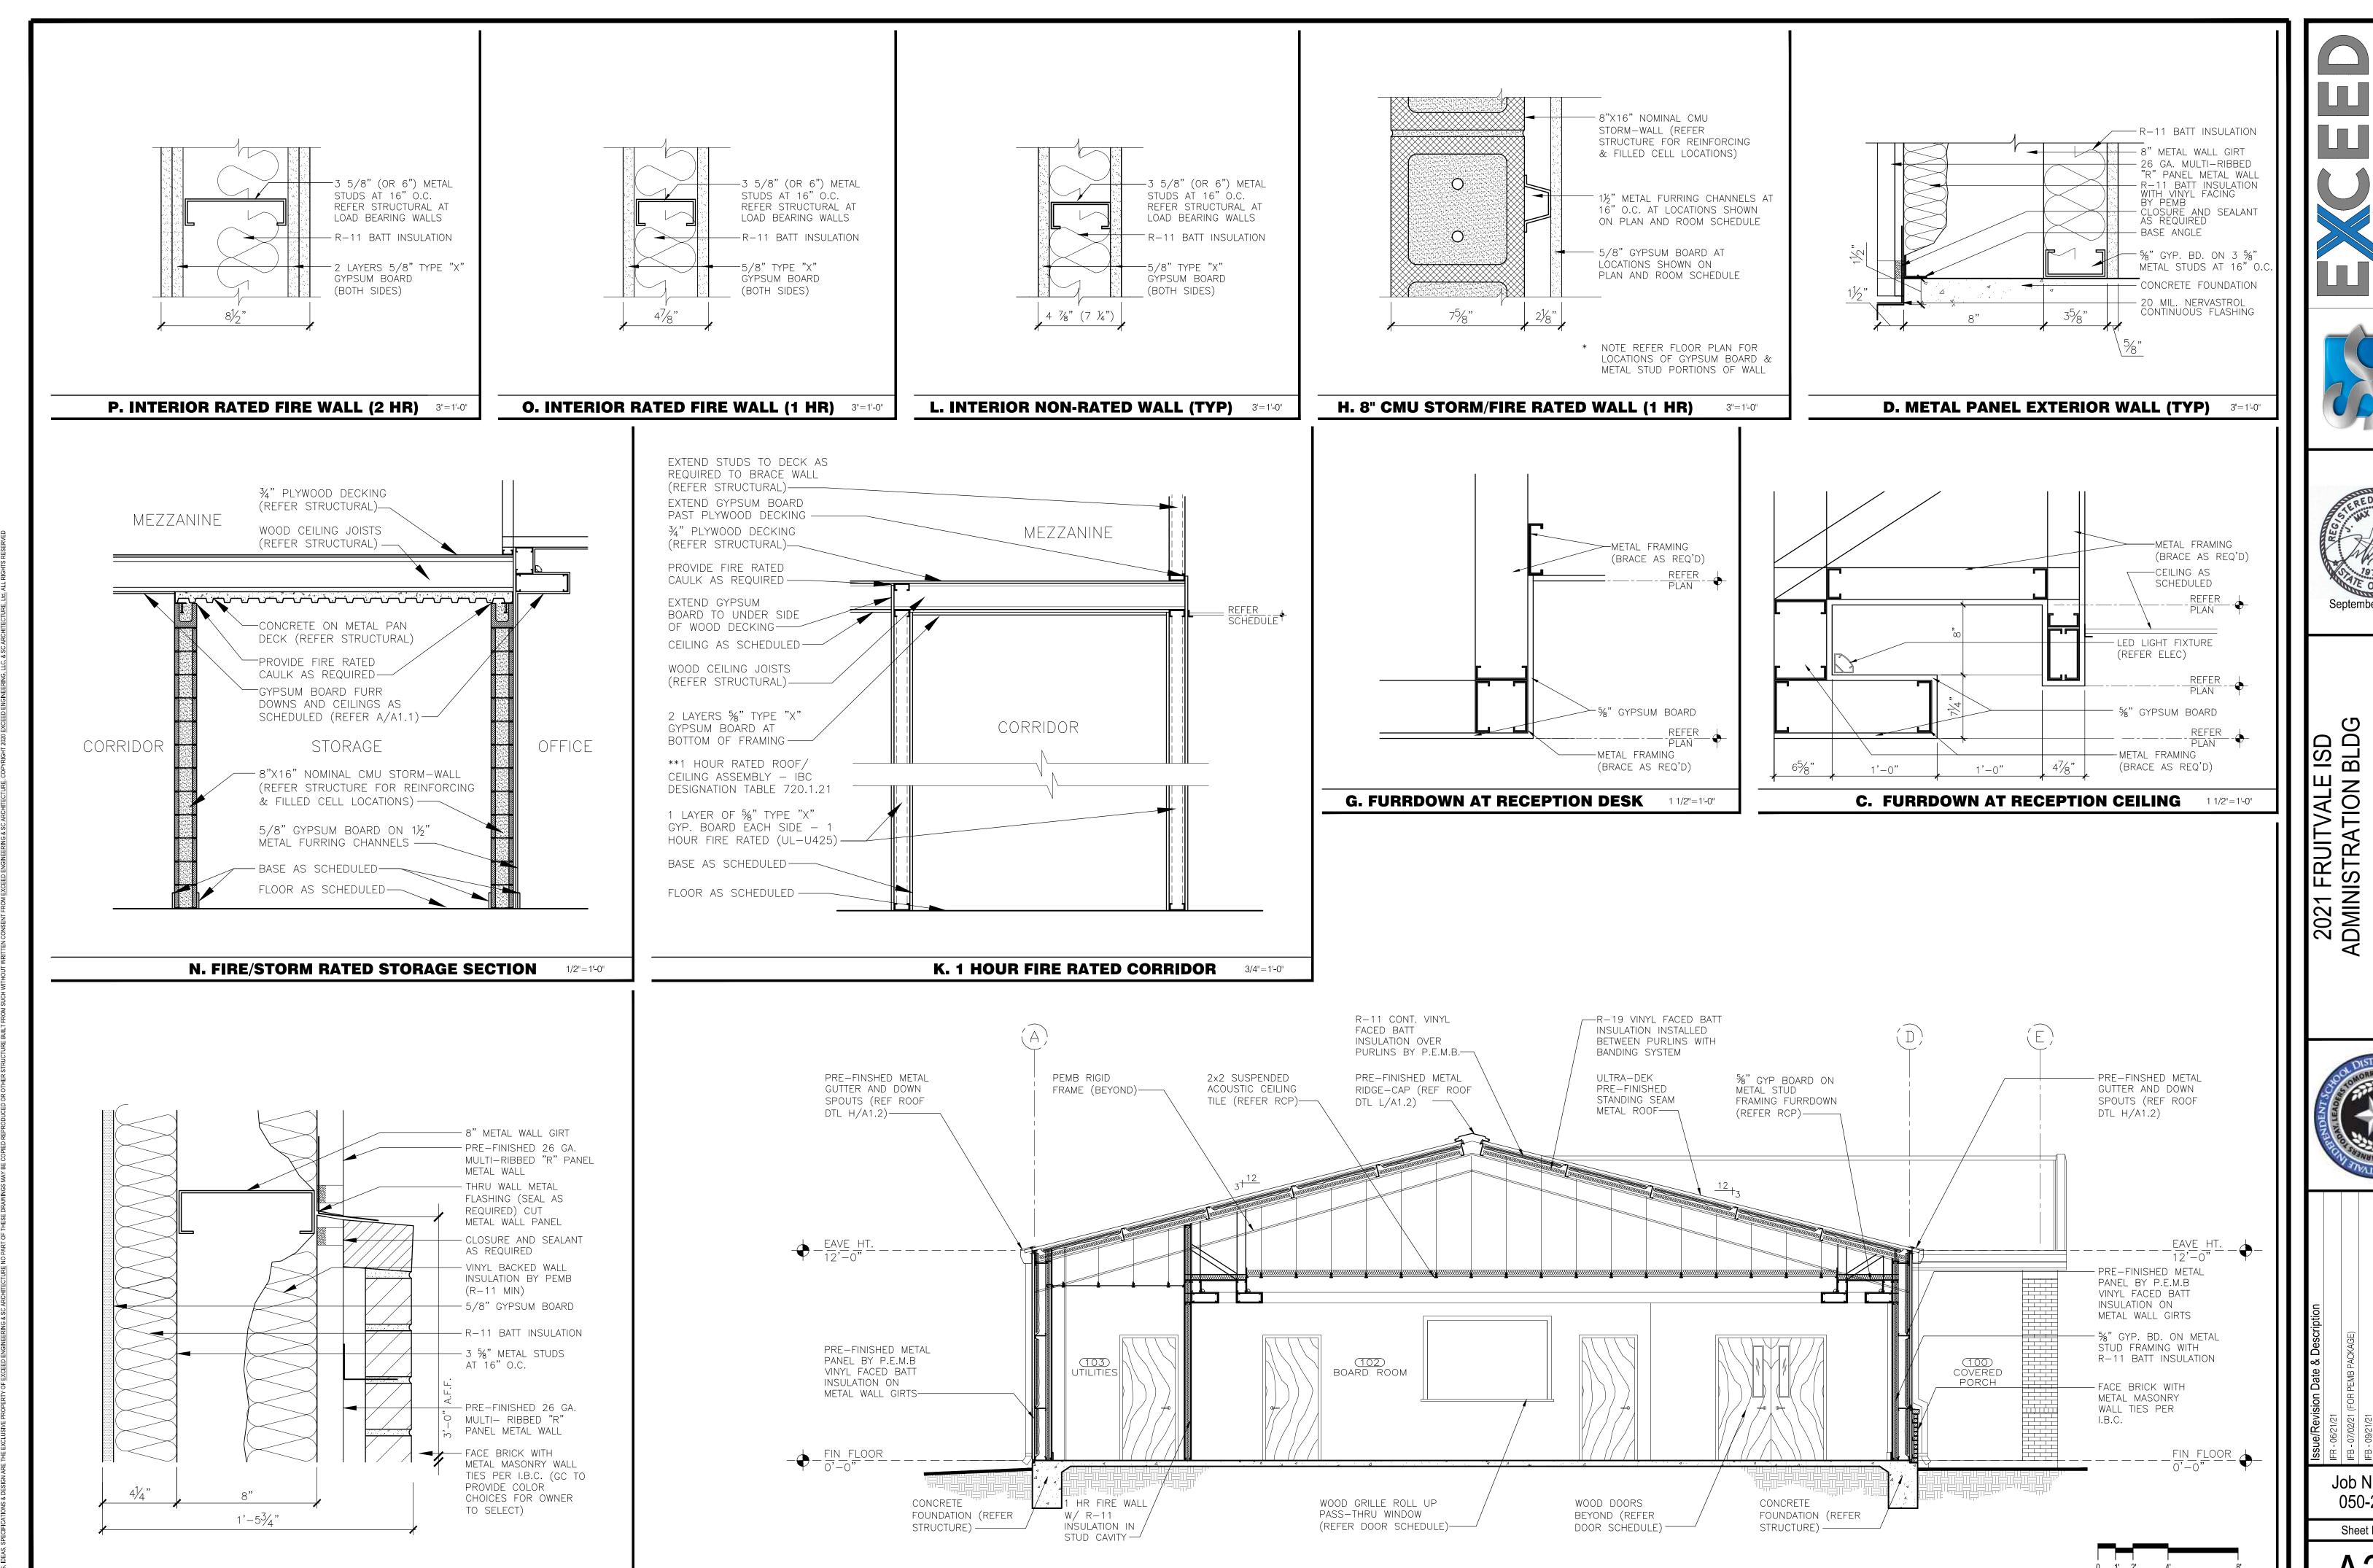

M. TYPICAL MASONRY WAINSCOT DETAIL




September 21, 2021




Job Number: 050-21003

Sheet Number:

A. BUILDING SECTION

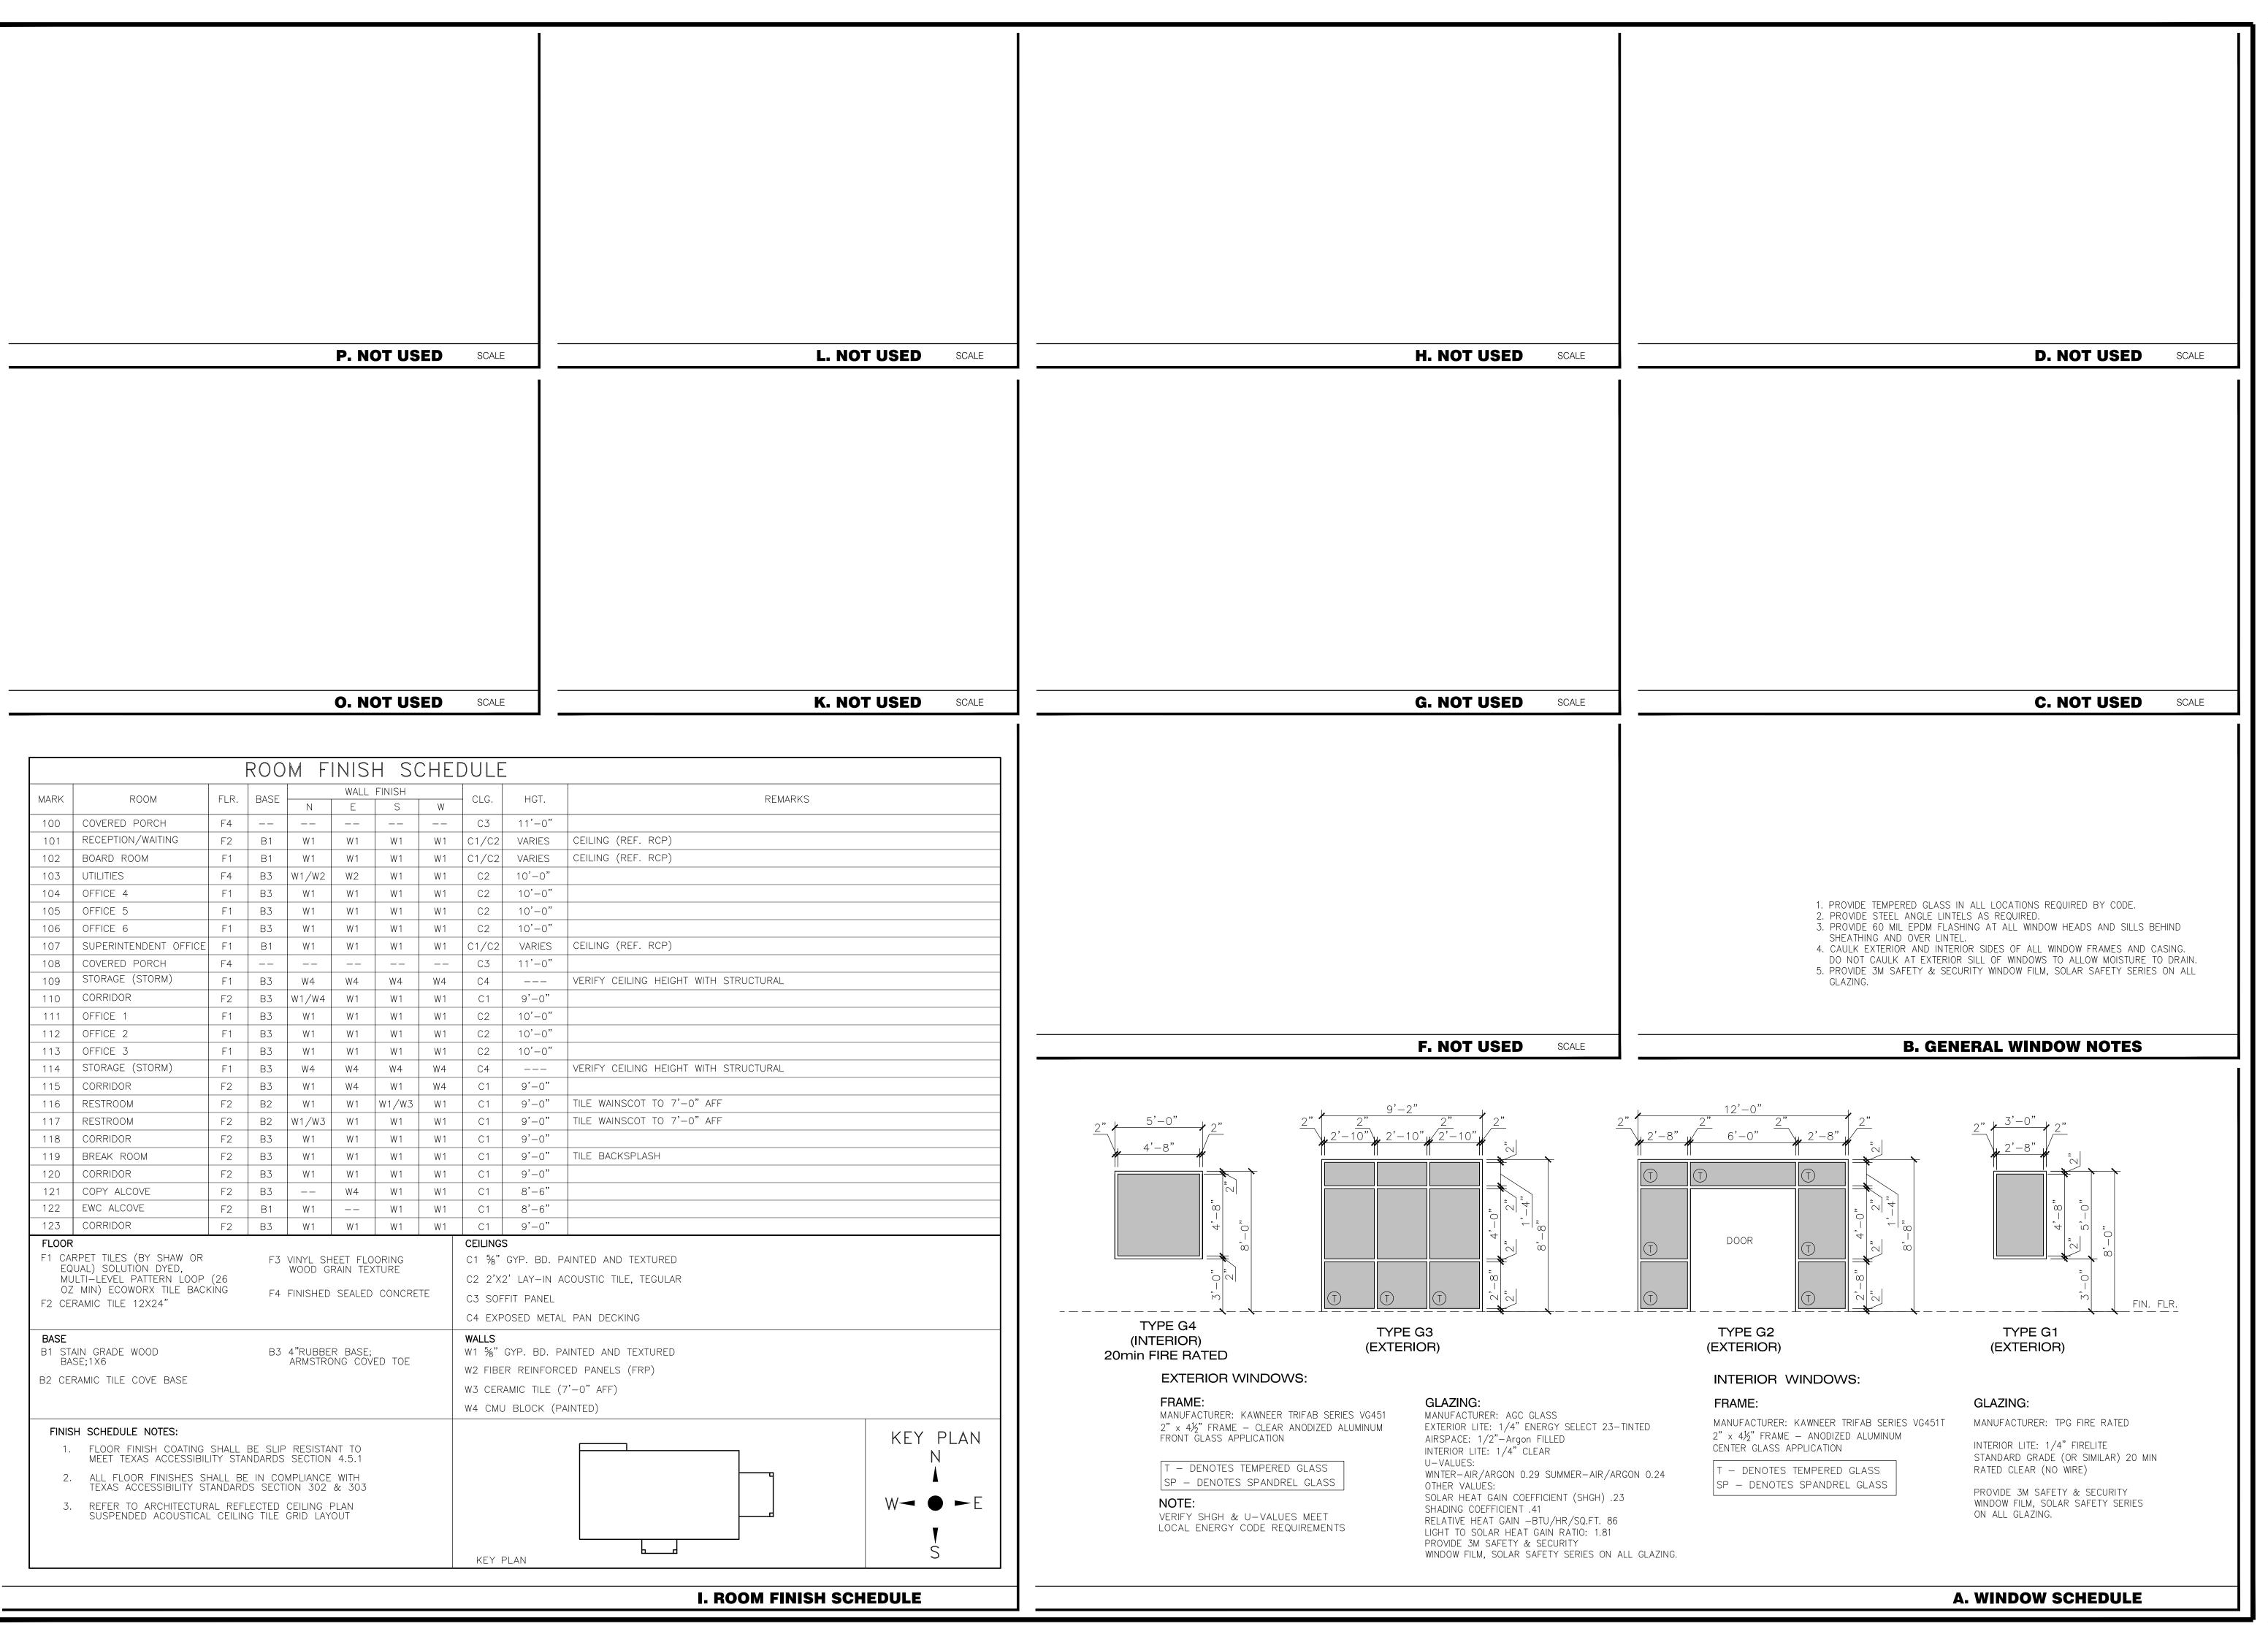




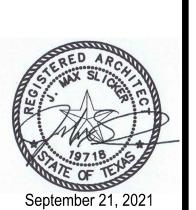


2021 FRUITVALE ADMINISTRATION E



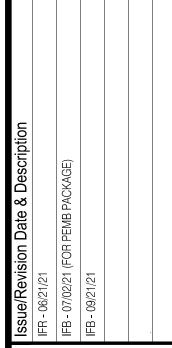

Job Number:

050-21003

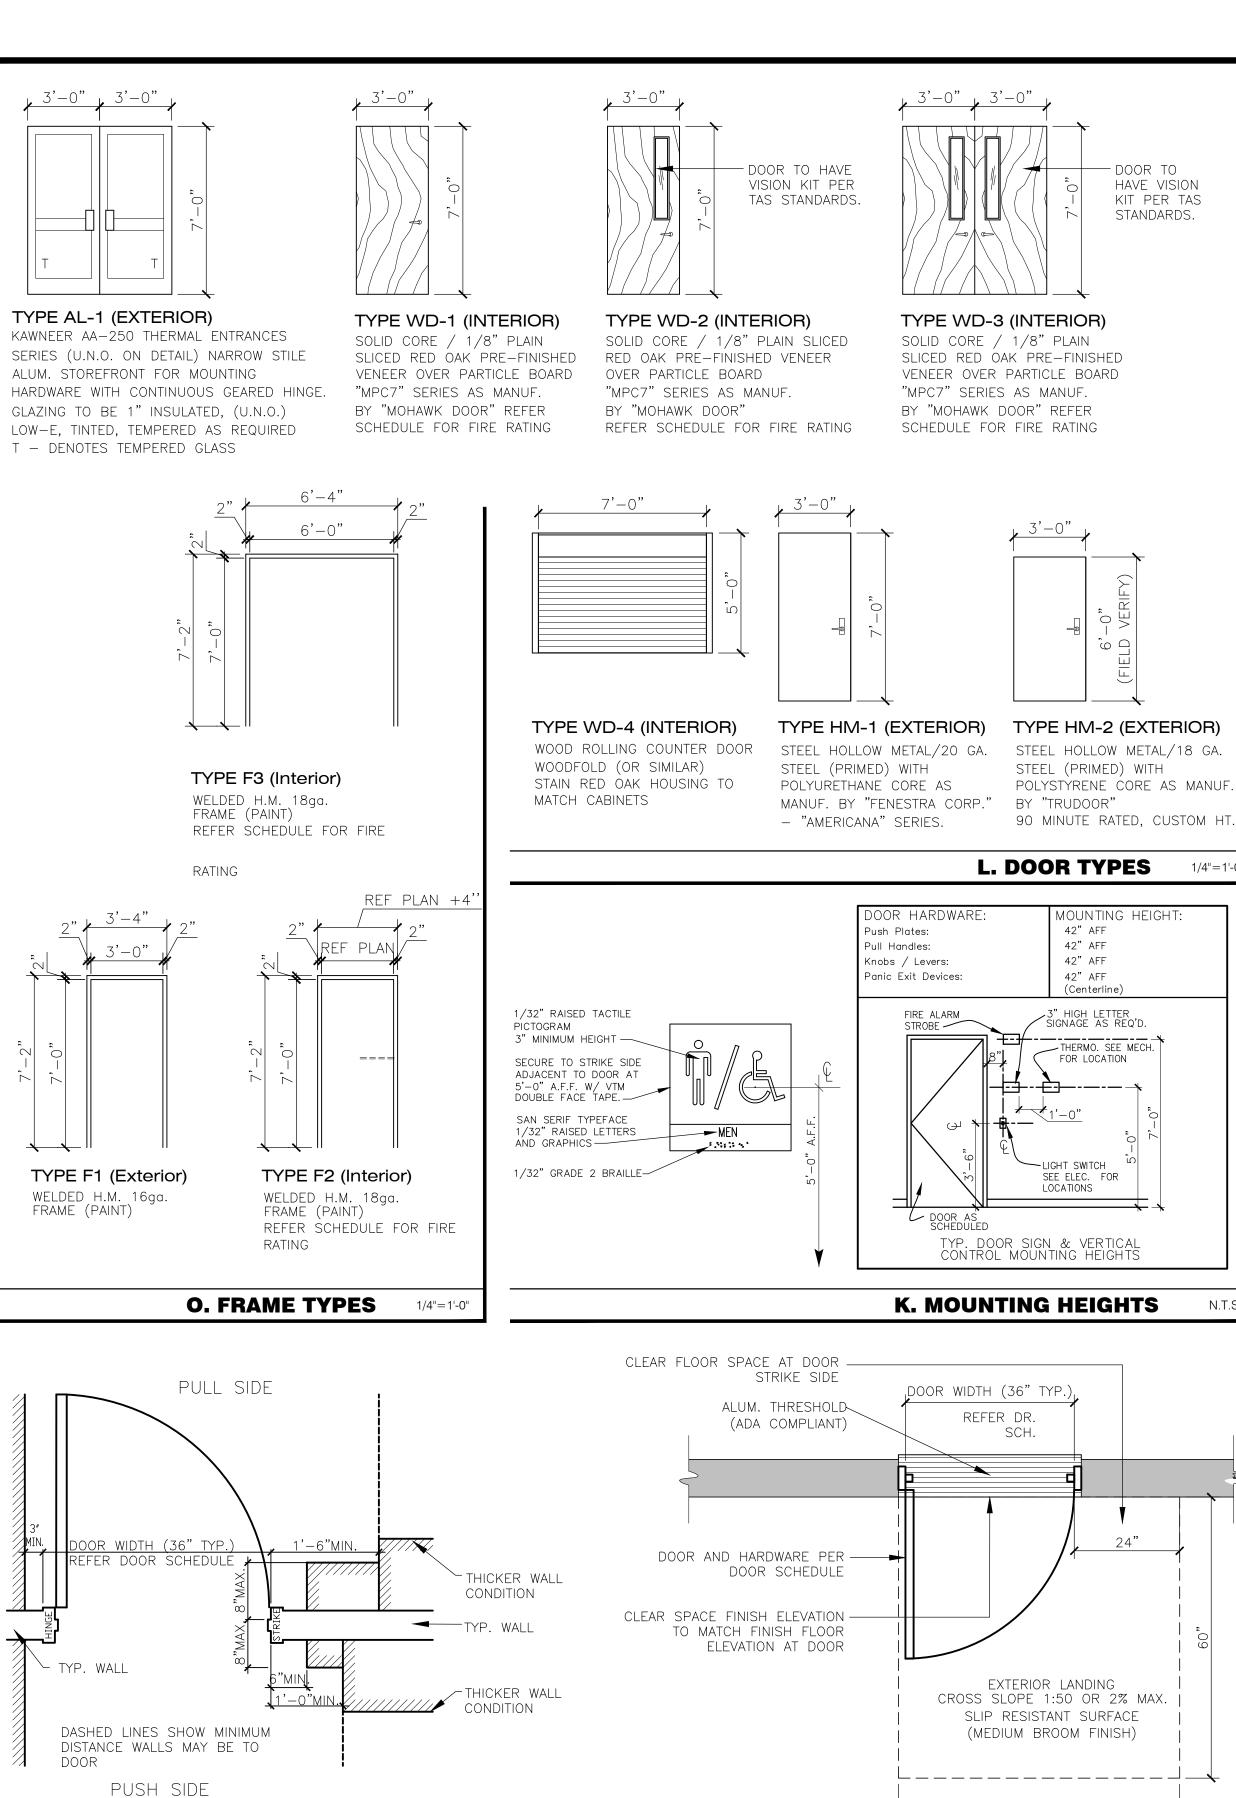

SCHEDULED DOOR-

INTERIOR DOOR

SCHEDULED

FLOOR FINISH

J. DOOR CLEARANCES — SCHEDULED DOOR DOOR

(101)

(102A)

(102B)

105

(106)

(109)

FROM ROOM

101 RECEPTION/WAITING

102 BOARD ROOM

102 BOARD ROOM

23 CORRIDOR

120 CORRIDOR

120 CORRIDOR

120 CORRIDOR

110 CORRIDOR

110 CORRIDOR

10 CORRIDOR

110 CORRIDOR

115 CORRIDOR

118 CORRIDOR

118 CORRIDOR

118 CORRIDOR

120 CORRIDOR

23 CORRIDOR

200 | 200 MEZZANINE

ABBREVIATIONS:

AL ALUMINUM

MAT'L MATERIAL

GENERAL NOTES:

ALUMINUM.

102 BOARD ROOM

119 BREAK ROOM

101 RECEPTION/WAITING

101 RECEPTION/WAITING

107 SUPERINTENDENT OFFICI

TO ROOM

123 CORRIDOR

103 UTILITIES

104 OFFICE 4

105 OFFICE 5

106 OFFICE 6

109 STORAGE

112 OFFICE 2

113 OFFICE 3

114 STORAGE

114 STORAGE

116 RESTROOM

117 RESTROOM

120 CORRIDOR

119 BREAK ROOM

119 BREAK ROOM

102 BOARD ROOM

200 MEZZANINE

WD WOOD

MTL METAL

. THRESHOLDS TO BE ADA APPROVED WITH 1/2" MAXIMUM VERTICAL

SILENCERS, AND A FLOOR OR WALL STOP. ALL EXTERIOR DOORS

RISE, BEVELED RISE SLOPE, NON SKID SURFACE MILL-FINISH

2. ALL DOOR LEAVES SHALL RECEIVE SET OF THREE BUTT HINGES,


100 COVERED PORCH (OUT)

107 SUPERINTENDENT OFFICE

108 COVERED PORCH (OUT)

108 COVERED PORCH (OUT)

101 RECEPTION/WAITING

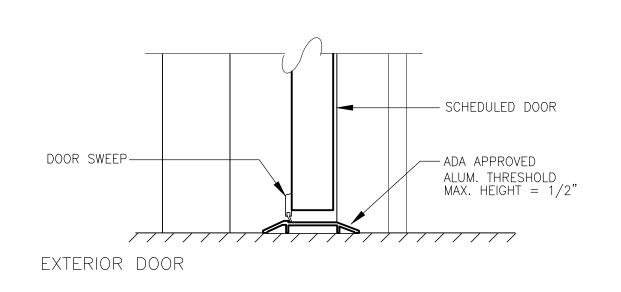

I. THRESHOLD DETAILS

H. NOT USED

SIZE (wxhxth)

(PAIR)36"x84"x2¼"

PAIR)36"x84"x1¾"

36"x84"x1¾"

42"x84"x1¾"

36"x84"x1¾"

36"x84"x1¾"

36"x84"x1¾"

36"x84"x1¾"

36"x84"x1¾"

36"x84"x1¾'

84"x60"

36"x84"x1¾"

36"×72"×1¾"

CLR CLEAR

GL CLASS

DOOR DATA

TYPE

AL-1

WD-3

WD-2

WD-1

WD-2

WD-2

WD-2

WD-2

HM-1

HM-1

WD-2

HM-1

HM-1

WD-1

WD-1

WD-2

WD-2

WD-2

WD-4

HM-1

HM-2

(22.2N) FOR INTERIOR DOORS.

MAT'L

AL/GL

WD

WD

WD

WD

НМ

НМ

WD

WD

WD

WD

WD

WD

НМ

SCALE

DOOR SCHEDULE

FINISH

ST

ST

ST

ST

ST

PT

ST

ST

ST

ST

ST

PT

HDWE HARDWARE

PT PAINTED

4. CONTRACTOR TO FIELD VERIFY ALL DOOR FRAME DEPTH WITH FIELD

6. FOR INTERIOR DOOR ROUGH OPENING SIZES CONTRACTOR SHALL VERIFY WITH

FRAMED WALL THICKNESS PRIOR TO ORDERING FRAMES.

5. MAXIMUM EFFORT TO OPERATE DOORS SHALL NOT EXCEED: 5.0 L.B.F.

FRAME DATA

4 3/4"

4 ¾"

4 3/4"

4 ¾"

4 ¾"

4 3/4"

4 ¾"

4 ¾"

4 3/4"

4 3/4"

4 ¾"

4 ¾"

4 3/4"

4 3/4"

4 3/4"

MAT'L

MTL

ST STAINED & SEALED

FF FACTORY FINISH

FINISH

PT

PT

REMARKS

H-1/C-1/L-5

H-1/C-1/L-1/B-1

H-1/C-1/L-1/B-1

H-1/C-1/L-1/B-1

H-1/C-1/L-1/B-1

H-1/C-1/L-1/B-1

H-1/L-6/C-1/B-3

H-1/L-6/C-1/B-3

H-1/C-1/L-1/B-1

H-1/C-1/L-1/B-1

H-1/C-1/B-1/L-3

H-1/C-1/B-1/L-3

H-1/L-5/B-1/C-1

H-1/L-6/C-1/B-3

H-1/L-2/C-1

H-1/L-2/C-1

H-1/L-2/C-1

TYPE

F3

F2

F1

LABEL

90 MINS

20 MINS

20 MINS

20 MINS

20 MINS

90 MINS

90 MINS

20 MINS | F2

D. NOT USED

ADA APPROVED THRESHOLD/WEATHER STRIPPING/CLOSER/PUSH AND PULL HANDLES/ ELECTROMAGNETIC LOCK WITH EXTERIOR KEYPAD & PUSH
BUTTON RELEASE AT RECEPTION DESK/(PAIR) REMOVABLE CENTER MULLION

(PAIR) H-1/C-1/L-5 WITH REMOVABLE CENTER MULLION

H-1/L-1/B-1/C-1 (FIRE AND STORM RATED)

H-1/L-1/B-1/C-1 (FIRE AND STORM RATED)

H-1/L-1/B-1/C-1 (FIRE AND STORM RATED)

OUTSIDE FACE MOUNTED FRAME, MANUAL LIFT.

CO CASED OPENING

HARDWARE IN SATIN CHROME FINISH (VERIFY WITH OWNER). ALL OTHER

PRECAUTIONS TO ENSURE LONG, TROUBLE FREE OPERATION. HARDWARE

SHALL BE ADJUSTED TO PROVIDE SMOOTH BALANCED DOOR MOVEMENTS.

9. ALL DOORS TO BE INSTALLED WITH HINGE REINFORCEMENTS OR OTHER

HARDWARE SHALL MATCH THE GRADE AND FINISH OF THE HANDLES.(U.N.O)

OHD OVER HEAD DOOR

FG FIBERGLASS

SCALE




2021 FRUITVALE | ADMINISTRATION E EXAS 7

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Sheet Number:

SHALL RECEIVE WEATHER STRIPPING, SWEEPS, AND THRESHOLDS. MAXIMUM DIAGONAL DISTORTION NOT TO EXCEED 1/16" FOR STEEL DOORS, MANUFACTURER. ALL HARDWARE REQUIRED FOR A COMPLETE DOOR SET SHALL BE 1/8" FOR WOOD DOORS. 7. CAULK EXTERIOR AND INTERIOR SIDES OF ALL DOOR FRAMES. 10.LATCHES AND LOCKS ON EMERGENCY EGRESS DOORS WITHOUT PANIC 3. ALL FIRE DOORS SHALL BE TESTED IN ACCORDANCE WITH ASTM E152 8. DOOR HARDWARE SHALL BE CORBIN RUSSWIN MEDIUM DUTY COMMERCIAL HARDWARE ARE TO BE INSTALLED PER LOCAL CODES AND LABELED PER LIFE SAFETY CODE. HARDWARE LEGEND MARK | DESCRIPTION MARK DESCRIPTION MARK DESCRIPTION CORBIN RUSSWIN KNUCKLE FULL— MORTISE LOOSE PIN SATIN CHROME BUTTS. 3 HINGES CORBIN RUSSWIN ED400 SERIES NARROW STYLE EXIT DEVICE 'TRIMCO" CONVEX RUBBER WALL BUMPER WITH LEVER LATCH - GEORGIA 125 STYLE ON OPPOSITE SIDE NO. 1270CV - SATIN CHROME PER DOOR UNIT. OF PANIC (OMIT KEY CYLINDER). CORBIN RUSSWIN ED400 SERIES NARROW STYLE EXIT DEVICE CORBIN RUSSWIN KEYED LEVER LOCKSET "TRIMCO" HINGE PIN STOP -SATIN CHROME WITH LEVER LATCH - GEORGIA 125 STYLE ON OPPOSITE SIDE CL3100 - 2 3/4" BACKSET. OF PANIC (WITH KEY CYLINDER). CORBIN RUSSWIN LEVER PASSAGE SET "TRIMCO" 1215CKU DOOR STOP-SATIN CHROME CL3100 - 2 3/4" BACKSET. CORBIN RUSSWIN LEVER PRIVACY SET "TRIMCO" 1254 WALL STOP AND HOLDER CORBIN RUSSWIN D-3000 SERIES CAST IRON DOOR CLOSER CL3100 - 2 3/4" BACKSET. ADA ARM, HOLD OPEN SATIN CHROME A. DOOR SCHEDULE

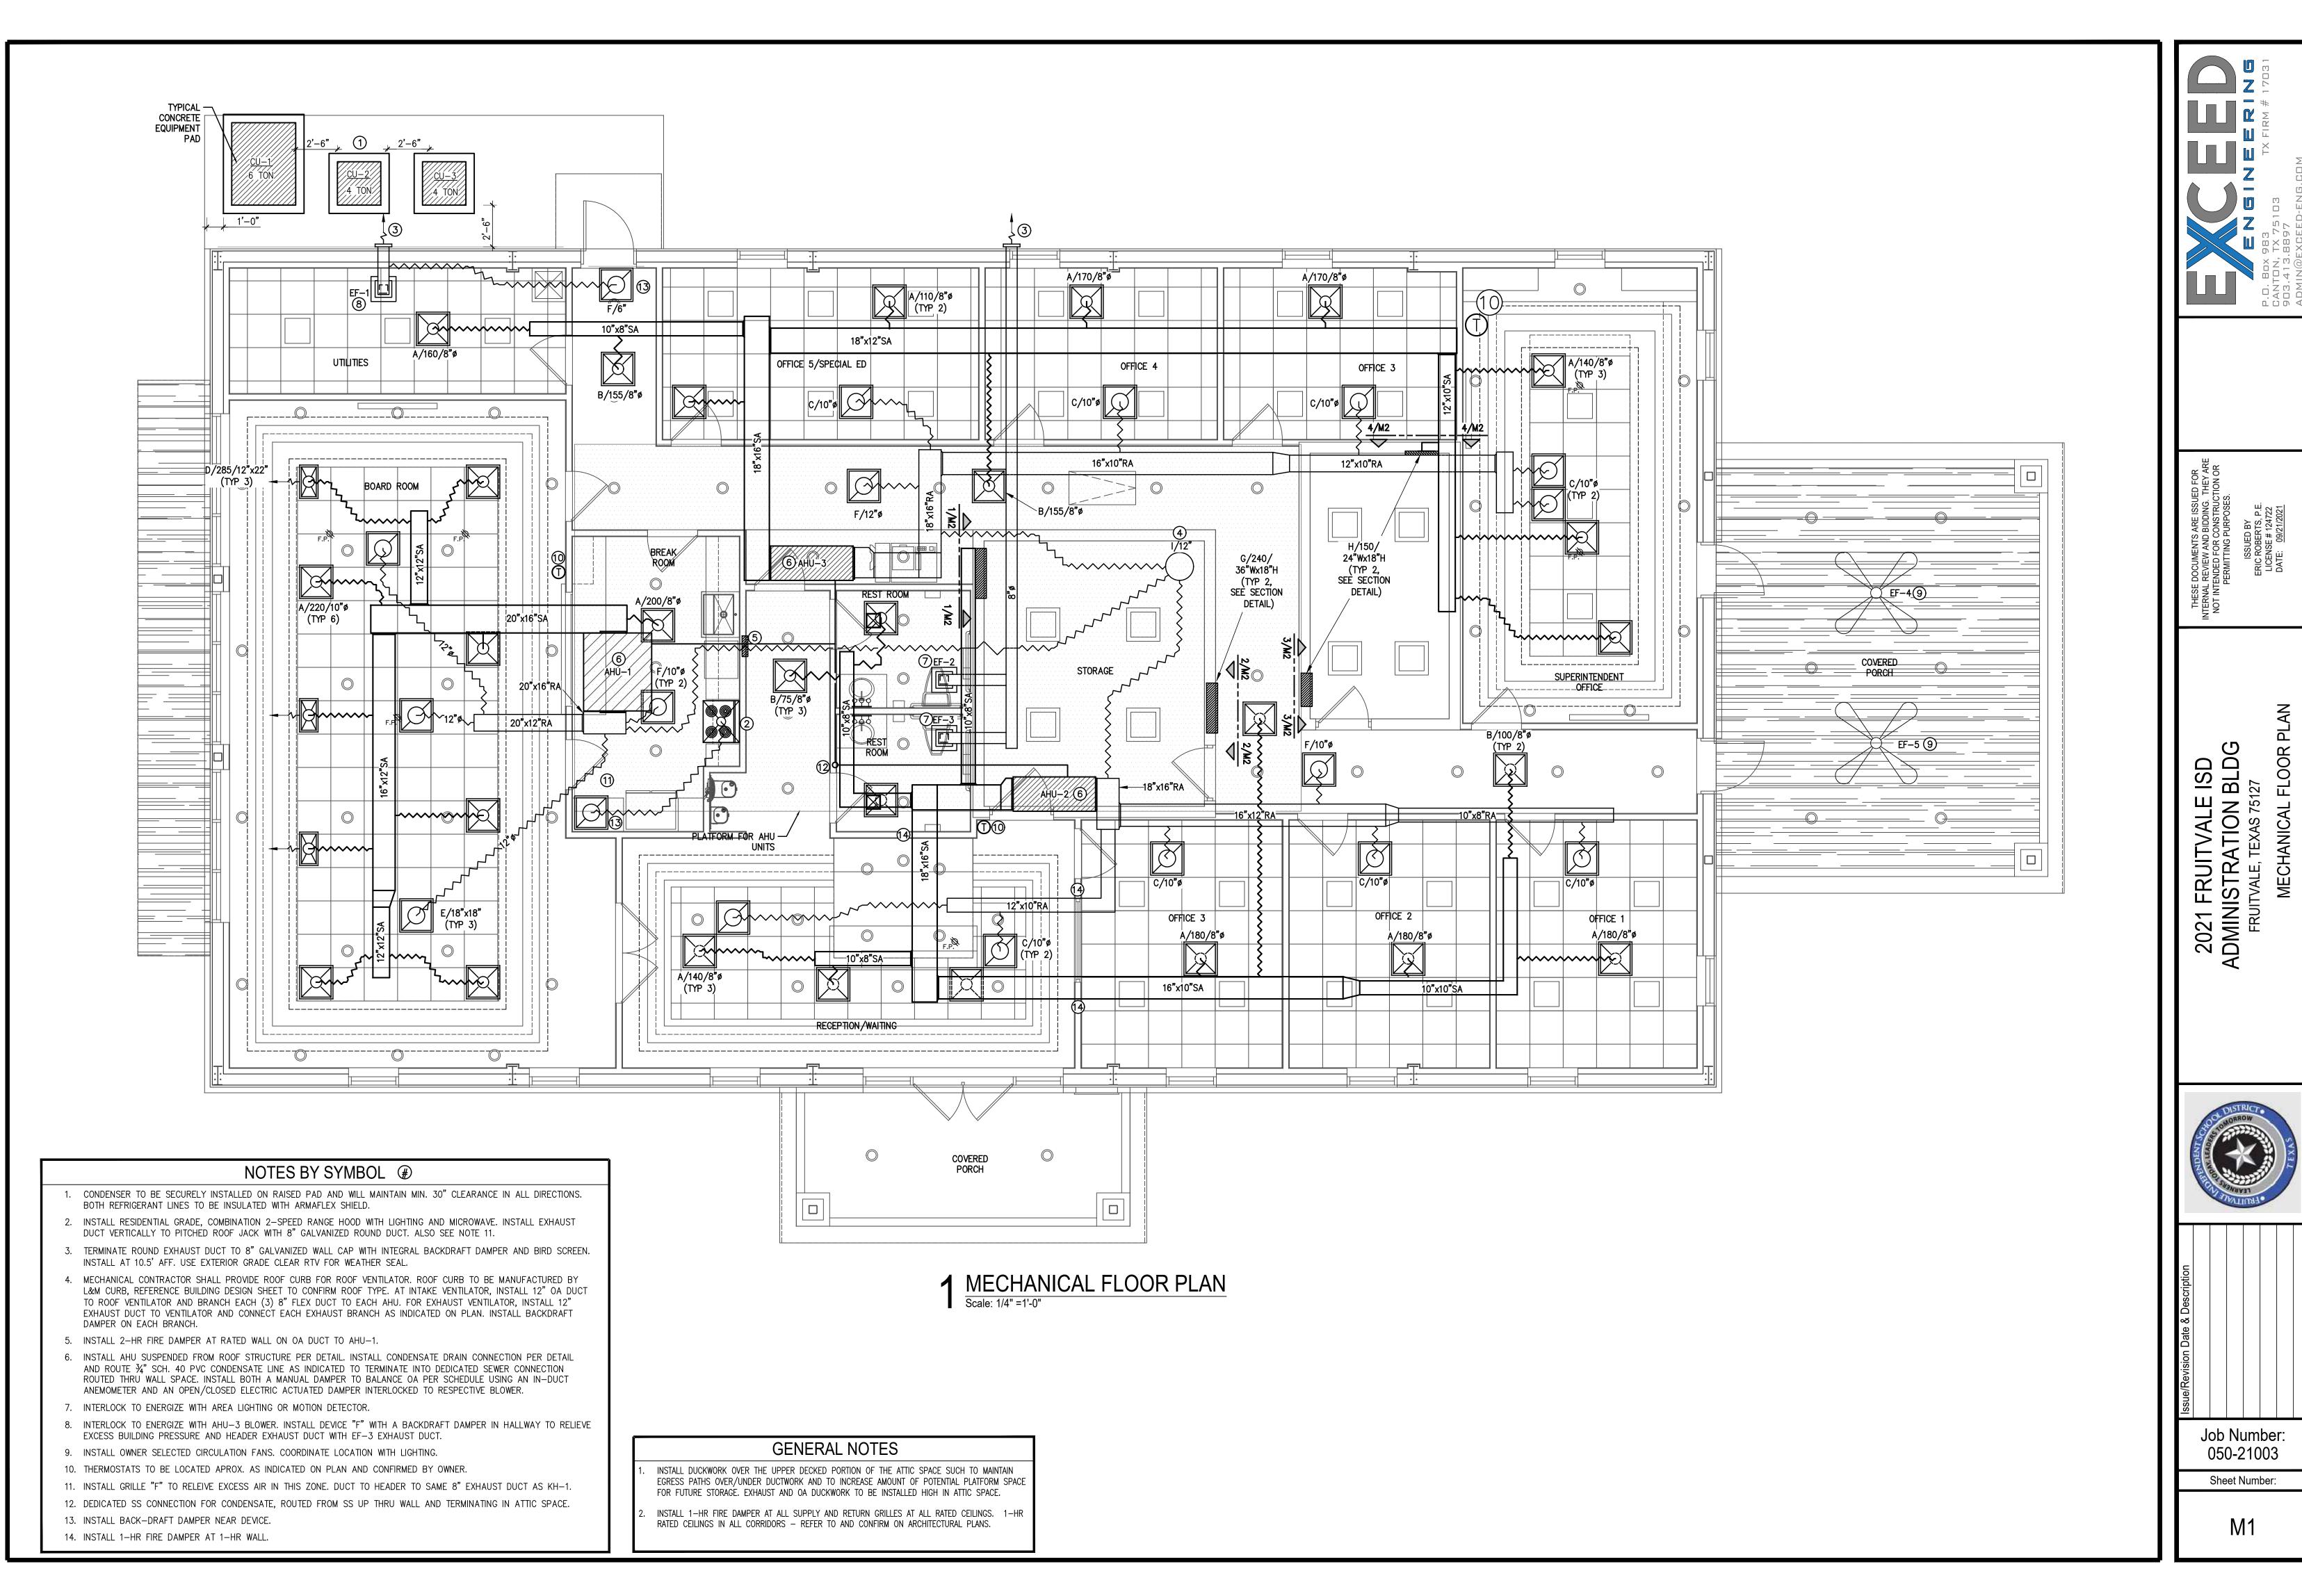


INSTALL TORNADO RATED LOUVER IN WALL PER MANUFACTORS RECOMMENDATIONS.
MOUNT FLUSH TO EXTERIOR OF STORAGE ROOM WALL.


G/240/36"x18"

2'-6"

1 SECTION DETAIL FOR LOUVER INSTALLATION AT STORAGE ROOM Scale: 1/4" =1'-0"

2 SECTION DETAIL FOR LOUVER INSTALLATION AT STORAGE ROOM Scale: 1/4" =1'-0"

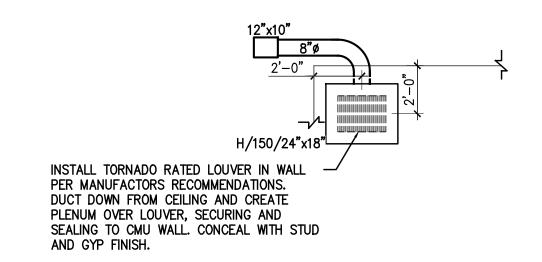

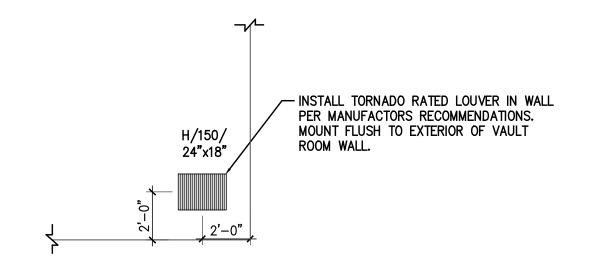

4 SECTION DETAIL FOR LOUVER INSTALLATION AT VAULT ROOM Scale: 1/4" =1'-0"

3 SECTION DETAIL FOR LOUVER INSTALLATION AT VAULT ROOM Scale: 1/4" =1'-0"

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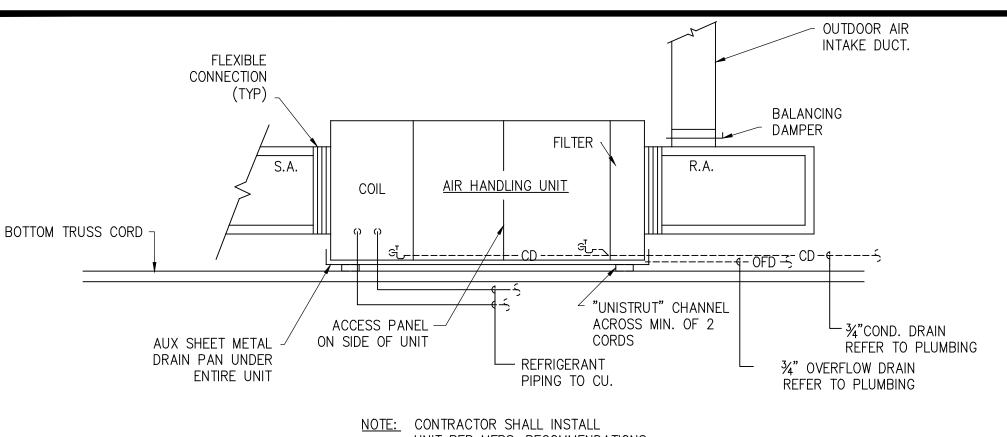
TEXAS MORNOLLO DE LA COMPANSION DE LA CO

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Job Number: 050-21003

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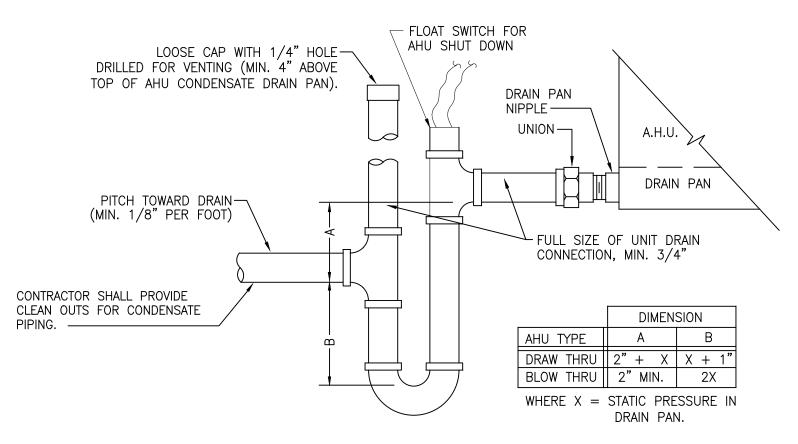


UNIT PER MFRS. RECOMMENDATIONS COORDINATE WITH STRUCTURAL


AHU DETAIL

ENGINEER'S DRAWINGS.

SCALE: N.T.S.




AHU CONDENSATE DRAIN CONNECTION SCALE: N.T.S.

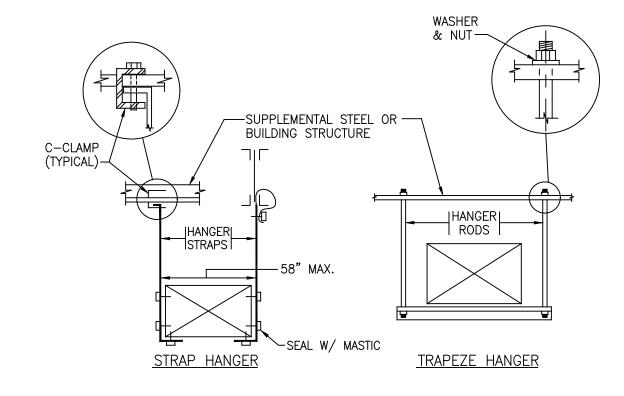


1. NO POP RIVETS ALLOWED, USE SELF-TAPPING SHEETMETAL SCREWS ONLY. 2. USE TRAPEZE HANGER FOR DUCTS WIDER THAN 58". 3. MAX. SPACING BETWEEN DUCT HANGERS SHALL BE 8 FT. (SEE SMACNA FOR STRAP WIDTH & GAGE [MIN. 1"X22 GA.]).

DUCT HANGER DETAIL

SCALE: N.T.S.

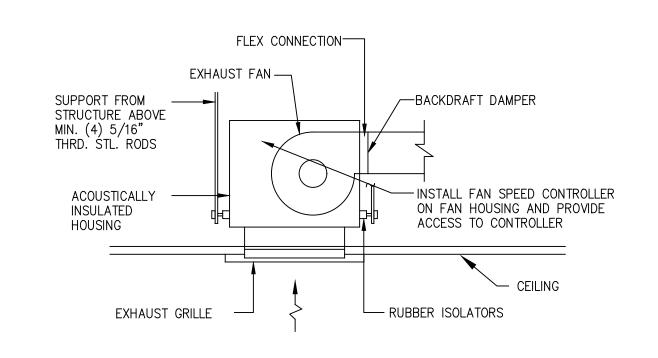


CEILING MTD. EXHAUST FAN

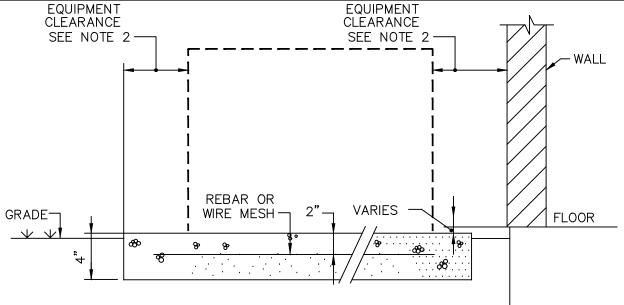

1. SLOPE SLAB A MINIMUM OF 1/2"/FOOT BACK TO FRONT OR

- CENTER TO EDGE FOR DRAINAGE.
- 2. MINIMUM CLEARANCE AROUND EQUIPMENT, ALL
- SIDES, PER MANUFACTURER. 3. DIMENSIONS SHOWN ARE MINIMUM ACCEPTABLE; REVISE AS REQUIRED FOR EQUIPMENT BEING PROVIDED.
- 4. WHERE WALL DOES NOT EXIST, INSTALL EQUIPMENT IN CENTER OF PAD AND ENCLOSE AS SHOWN ON ARCHITECTURAL DRAWINGS.

CONDENSING EQUIPMENT PAD DETAIL SCALE: N.T.S.

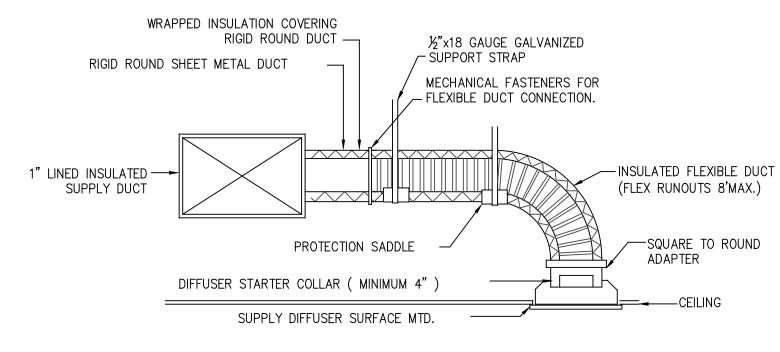

DUCT CONNECTION DETAIL SCALE: N.T.S.

GENERAL NOTES

- DUCTWORK SHALL BE RUN AS SHOWN, BUT SHALL CONFORM TO STRUCTURAL AND FINISH
- . BUILDING AIR SYSTEMS SHALL BE BALANCED PER DATA INCLUDED ON THE DRAWINGS TO ACHIEVE RELATIVE AIR VOLUMES AS INDICATED ON THE DRAWINGS AND SCHEDULED HEREIN.
- C. DUCT SIZES INDICATED ON DRAWINGS ARE CLEAR INTERNAL DIMENSIONS.
- D. SQUARE, RECTANGULAR AND ROUND DUCTWORK SHALL BE CONSTRUCTED OF NEW GALVANIZED PRIME GRADE SHEET STEEL MEETING THE REQUIREMENTS OF 'SMACNA' DUCT CONSTRUCTION STANDARDS.
- EXTERIOR SA & RA DUCT SYSTEMS TO BE INTERNALLY LINED WITH AP ARMAFLEX SELF-ADHERING CLOSED CELL ELASTOMERIC INSULATION 2" THICK, R-8 RATED. INTERIOR SA & RA DUCT SYSTEMS TO BE EXTERNALLY WRAPPED WITH FIBER GLASS INSULATION SYSTEM 2" THICK, R-8 RATED. EXPOSED INTERIOR DUCT SYSTEMS SHALL BE JACKETED WITH AL JACKETING. DIMENSIONS ON PLAN ARE FREE INTERNAL DIMENSIONS. USE OUTDOOR GRADE CLEAR RTV SILICONE TO SEAL DUCT
- DUCTS SHALL BE SUPPORTED AT ALL TURNS AND TRANSITIONS AND NOT MORE THAN 8'-0" O.C. STRAIGHT DUCTS UP TO 59" MAX DIMENSIONS SHALL BE SUPPORTED AT 4'-0" O.C.
- C. ALL DUCTS REQUIRING REINFORCEMENT SHALL BE REINFORCED ACCORDING TO THE LATEST EDITION OF 'SMACNA' MANUAL. MATERIALS FOR REINFORCEMENT MEMBERS SHALL BE GALVANIZED STEEL. ALL SCREWS AND WASHERS SHALL BE PLATED OR GALVANIZED.
- H. ALL DEVICE BALANCE WORK TO BE CONFIRMED WITH INDUCT ANEMOMETER AND DOCUMENTED. SUBMIT A RECORD COPY TO EXCEED ENGINEERING.
- LOCATE EQUIPMENT AND FIXTURES APPROXIMATELY AS SHOWN CONFORMING TO BUILDING AND STRUCTURAL ITEMS, PROVIDE SUPPORTS, HANGERS AND OPENINGS AS REQUIRED FOR A COMPLETE INSTALLATION. CONTRACTOR SHALL COORDINATE WITH ALL TRADES FOR CLEARANCES, AND EXACT LOCATIONS OF EQUIPMENT. EQUIPMENT AND FIXTURES SHALL BE INSTALLED PER MANUFACTURERS RECOMMENDATIONS AND IN FULL ACCORDANCE WITH APPLICABLE CODES HAVING JURISDICTION.
- PROVIDE ELECTRONIC PROGRAMMABLE THERMOSTAT WITH SUB-BASE, TRANSFORMERS AND 24 VOLT CONTROL WIRING. ELECTRICAL CONTRACTOR SHALL PROVIDE POWER WIRING. THERMOSTATS SHALL BE MOUNTED 48" A.F.F. VERIFY FINAL LOCATION WITH OWNER.

MECHANICAL SYMBOLS

- SUPPLY AIR DUCT OR GRILLE
- RETURN AIR DUCT OR GRILLE
- R.A. RETURN AIR
- S.A. SUPPLY AIR E.A. EXHAUST AIR
- SD) DUCT SMOKE DETECTOR
- DUCT SENSOR FOR THERMOSTAT
- THERMOSTAT CHS CHILLED WATER SUPPLY
- CHR CHILLED WATER RETURN IS HOT WATER SUPPLY HOT WATER RETURN
- A. OUTSIDE AIR .D. FIRE DAMPER
- FLEX DUCT
- RIGID TRUNK DUCT
- --- RIGID BRANCH DUCT
- ALL SYMBOLS MAY NOT BE USED.

	INDOOR AIR HANDLING SCHEDULE														
MARK	MFR.	MODEL NO.	UNIT	UNIT	VOLTS	HZ	PH	MCA	TOTAL	FAN	ELEC. HEAT	CIRC. BREAKER		FILTERS	
			WT.	SIZE					CFM	MOTOR	(KW)	(AMP)	NO.	SIZE	TYPE
AHU-1	CARRIER	40RUQA07T1A5-0A1A0	400 LBS.	6 TONS	208	60	3	34.5	2400	2.4 HP	7.5 KW	35	4	2"x16"x24"	MERV 10
AHU-2&3	CARRIER	FE4ANB006000	207 LBS.	4 TONS	208	60	1	53.8	1600	TBD	7.5 KW	60	1	NOTE 7	MERV 10

FIELD INSTALLED ACCESSORIES:

) PROVIDE UNITS WITH 7-DAY PROGRAMMABLE THERMOSTATS WITH NIGHT SET BACK CAPABILITIES.

CONTRACTOR TO PROVIDE: 1) ELECTRICAL DISCONNECT SWITCH

MFR.

CARRIER

CARRIER

2) HACR BREAKERS

1. REFRIGERANT R-410A

SINGLE POINT POWER

IF INTEGRAL CIRCUIT BREAKER, USE FOR UNIT DISCONNECT REFER TO FLOOR PLAN FOR O.A. CFM PER UNIT.

RUUD, TRANE, CARRIER, BRYANT, YORK, GOODMAN, AND LENNOX ARE CONSIDERED EQUIVALENT MANUFACTURERS.

6. BALANCE OA USING IN-DUCT ANEMOMETER. OA: AHU-1 265 CFM; AHU-2 175 CFM; AHU-3 210 CFM.

7. OPT. FILTER KIT TO BE INCLUDED W/A.H. & SUPPLIED W/FILTERS. 8. INSTALL BACKUP ELECTRIC HEAT STRIPS PER SCHEDULE.

COND	ENSIN(G UN	NT S	SCHED	ULE-HEA	AT PUM	1P		
UNIT SIZE	VOLTS	HZ	PH	MCA	CIRCUIT BREAKER	LIQUID LINE	VAPOR LINE	REFRIG.	COOLING CAPACITY

30A

50A

MARK

CU-2 & 3

1) PROVIDE DISCONNECT, TO BE FIELD MOUNTED BY ELECTRICAL CONTRACTOR.

WT.

400 LBS.

LBS.

6 TONS

4 TONS

208

208

60

60

MODEL NO.

38AUQE07A0A5-0A0C0

25VNA848A0030

CONTRACTOR TO PROVIDE: 1) ELEC. DISCONNECT SWITCH

¾"O.D.

1½"O.D.

1%"O.D.

R-410A

R-410A

70 MBH

47 MBH

2) HACR BREAKERS

	FAN SCHEDULE													
MARK TYPI	TYPE	CFM	S.P. (IN	DRIVE	MOTOR DATA		SERVES	EQUA	L TO	UNIT WEIGHT	NOTES			
IVIZITAL	111 -	OI IVI	W.C.)	DITIVE	HP/WATTS	VOLTS	PH	OLIVEO	MFR.	MODEL	OWN WEIGHT	NOTEO		
EF-1,2,&3	CEILING	110	.1	DIRECT	25W	115	1	MECH. RM. & RESTROOMS	BROAN	AE110	10	1&2		
EF-4&5	CIRCULATION	_	_	DIRECT	TBD	115	1	РАПО	BY OWNER EXTERIOR RATED	-	_	3		
RH-1	2 SPEED DUCTED RANGE HOOD WITH LIGHT & MW	140- 220	.1	DIRECT	TBD	115	1	OVEN RANGE	BY OWNER	-	_	3		

EF-1/2/3-PROVIDE WITH FACTORY BACKDRAFT DAMPER. 3. COORDINATE COLOR/STYLE OR ALTERNATIVE EQUIVALENT MODEL WITH 2. EF-1/2 INTERLOCK START/STOP WITH LIGHT SWITCH OR MOTION DETECTOR. EF-3 INTERLOCK WITH AHU-3 BLOWER.

APPROVED MANUFACTURER'S: GREENHECK. BROAN, LOREN COOK,ACME AND PENN.

	LOUVER SCHEDULE												
MARK	MFR.	MODEL NO.	SIZE	FREE AREA (FT2)	TYPE								
G	RUSKIN	XP500WD	36"Wx18"H	.89	WIND DRIVEN RAIN LOUVER; FEMA P-361 AND ICC 500 COMPLIANT								
Н	RUSKIN	XP500WD	24"Wx18"H	.53	WIND DRIVEN RAIN LOUVER; FEMA P-361 AND ICC 500 COMPLIANT								
NOTES:													

COORDINATE FINISH/COLOR WITH OWNER.

	ROOF VENTILATOR SCHEDULE												
MARK	MFR. MODEL NO. SIZE TYPE												
l	GREENHECK GRSI 12" DIA GRAVITY INTAKE VENTILATOR												
NOTES:				•									

COORDINATE FINISH/COLOR WITH OWNER. PROVIDE AND INSTALL INSECT SCREEN

MECHANICAL CONTRACTOR TO PROVIDE ROOF CURB FOR EACH VENTILATOR.

INCLUDE OPT. FACTORY INSTALLED DAMPER ARRANGED FOR INTAKE.

	AIR DEVICE SCHEDULE											
PLAN MARK	METAL AIRE MODEL	FACE SIZE	TYPE									
A	PHENOM-6 AS	24"x24" TBAR LAY-IN	ULTRA HIGH PERFORMANCE SUPPLY DIFFUSER. 24"x24" TBAR LAY—IN. ALUMINIZED STEEL. NOTE 5.									
В	PHENOM-1 AS	24"x24" SURF. MOUNT	ULTRA HIGH PERFORMANCE SUPPLY DIFFUSER. 24"x24" SURF. MOUNT. ALUMINIZED STEEL. NOTE 5.									
С	7300R-6 AF	24"x24" TBAR LAY–IN	PERFORATED RETURN GRILLE. ALUMINIZED STEEL. FOIL LINED, FIBERGLASS BACKED. NOTE 5.									
D	LFL-1W-6	12"x22" LIST SIZE	1-WAY DIRECTIONAL LOUVER FACE LINEAR DIFFUSER. ALUMINUM. (SIZED TO FIT IN SPLIT 2'x2' CEILING TBAR CELL.)									
E	CC45-8	18"x18" LIST SIZE	SIGHT PROOF CUBE CORE RETURN GRILLE. LAY—IN TBAR. FILLER PANEL TO FIT STANDARD 2'x2' CEILING TBAR CELL. ALUMINUM.									
F	CC45-1	12"x12" LIST SIZE	SIGHT PROOF CURB CORE RETURN GRILLE. SURFACE MOUNT. ALUMINUM.									

COORDINATE LOCATION OF DIFFUSERS WITH ARCHITECTURAL REFLECTED CEILING PLAN. TITUS, PRICE, KRUEGER AND TUTTLE & BAILEY ARE CONSIDERED EQUIVALENT MANUFACTURERS. AIRFLOW QUANTITY NOTED ON MECH. DRAWINGS.

COORDINATE WITH OWNER FOR COLOR.

NECK SIZES SHALL BE SIZED AS SHOWN ON PLAN.

CONTRACTOR NOTES


CONTRACTOR SHALL PROVIDE EQUIPMENT AND/OR MATERIALS SUBMITTALS TO THE ENGINEER FOR REVIEW AND APPROVAL PRIOR TO ORDERING. SUBMITTALS REQUIRED FOR THIS PROJECT INCLUDE BUT ARE NOT LIMITED TO ROOF TOP UNITS, UNISTRUT USED FOR EQUIPMENT SUPPORT, AIR DISTRIBUTIONS DEVICES AND DUCTWORK.



2021 FR ADMINIST



Job Number: 050-21003

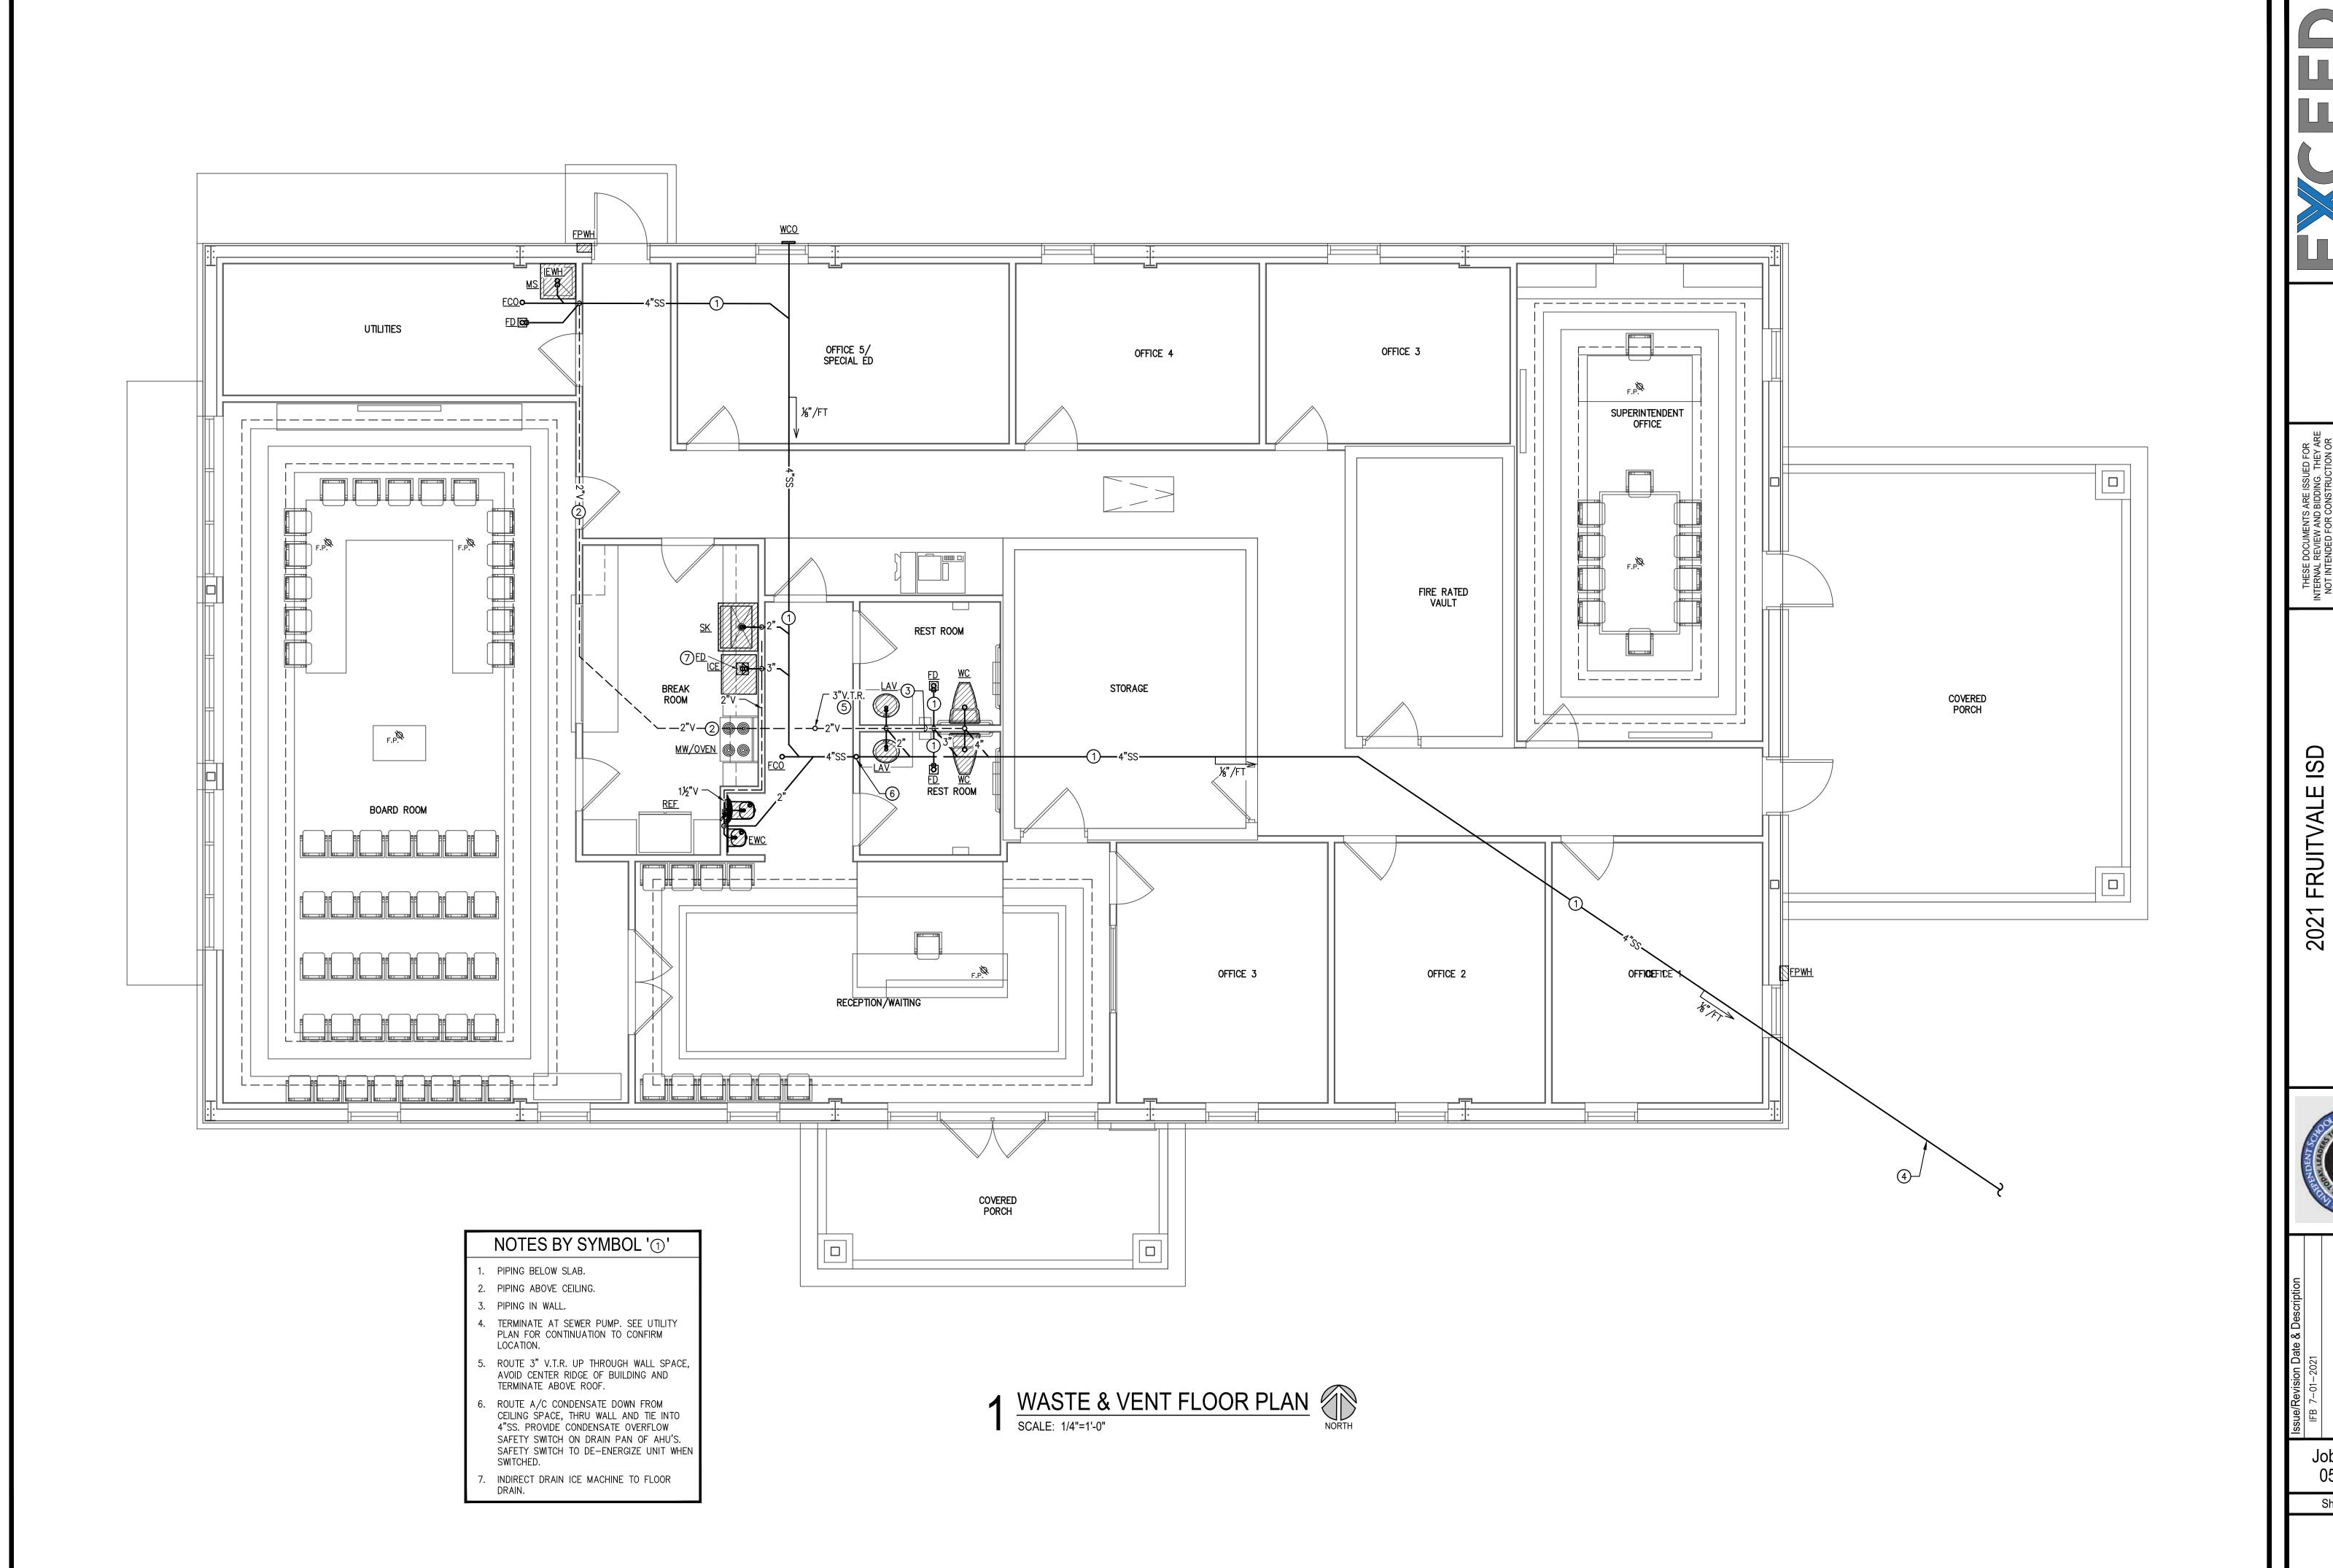

E N G I N E E R I N G I N E E R I N G I N E E R I N G I N E

PERMITTING PURPOSES.
ISSUED BY
ERIC ROBERTS, P.E.
LICENSE # 124722

2021 FRUITVALE ISD ADMINISTRATION BLDG FRUITVALE, TEXAS 75127 WASTE & VENT FLOOR PLAN




ue/Revision Date & Description FB 7-01-2021

Job Number: 050-21003

Sheet Number:

P1

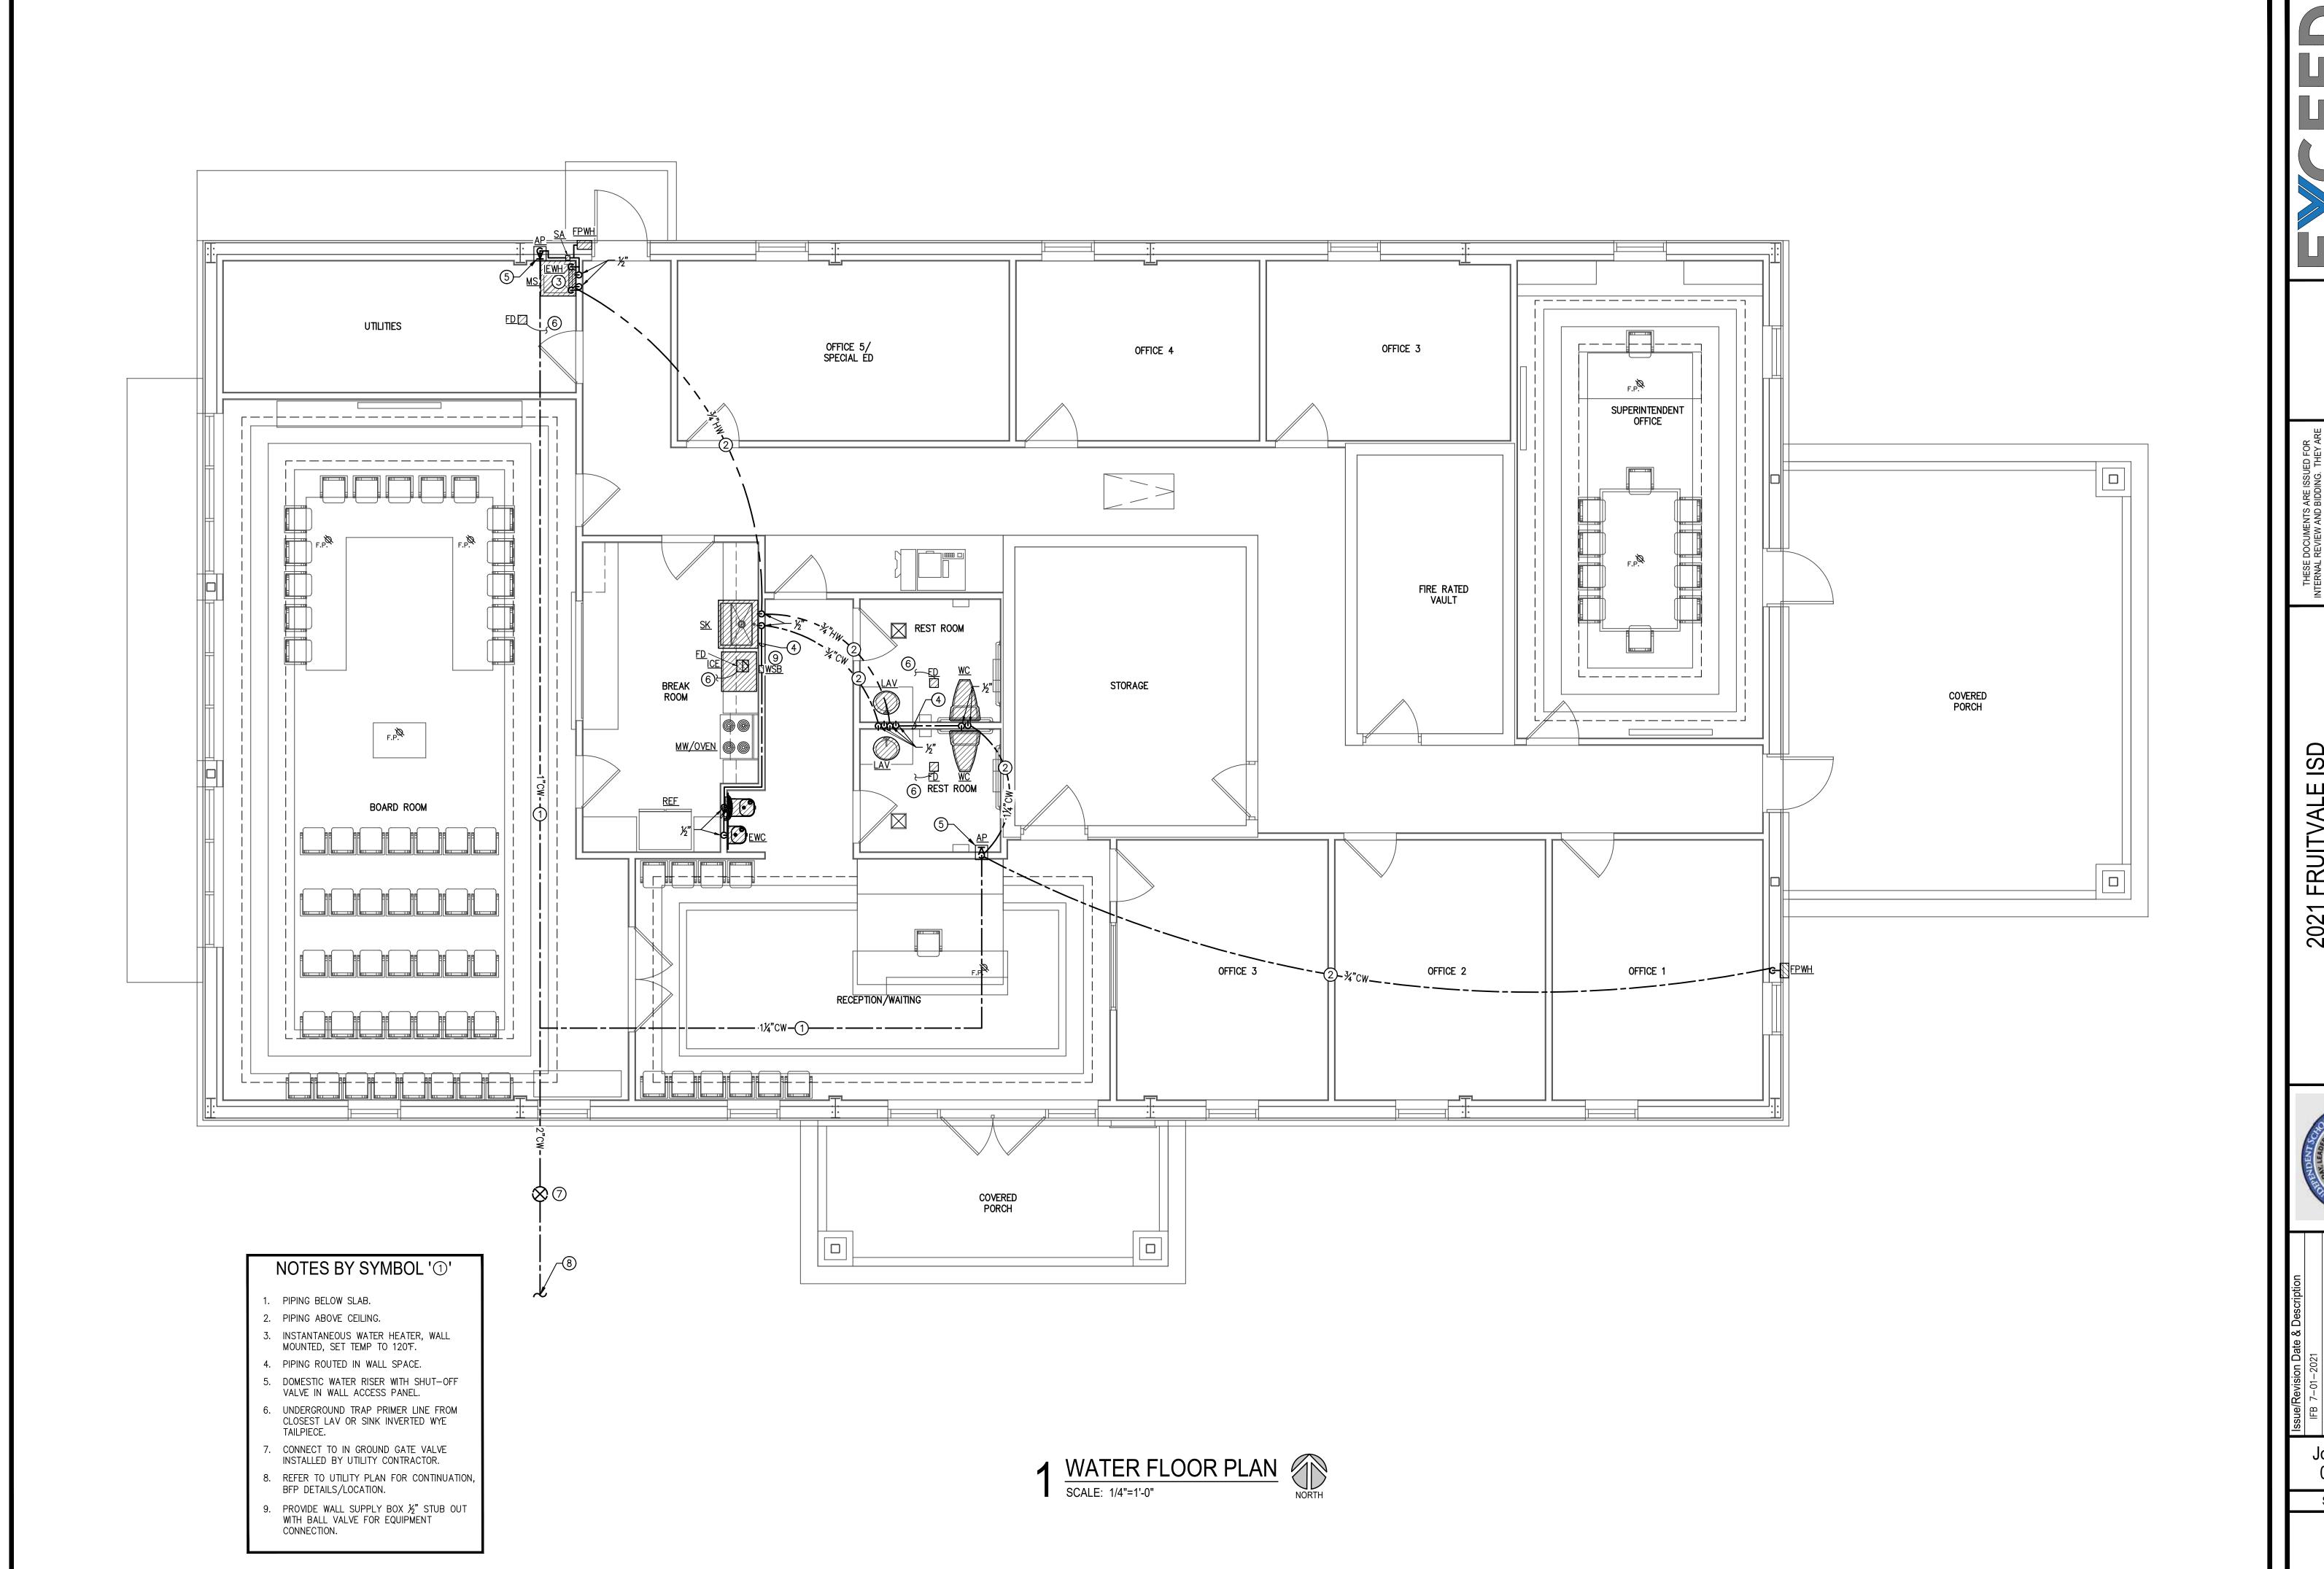

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ADMIN @ EXCEED-ENG.COM

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ERIC ROBERTS, P.E.
LICENSE # 124722

2021 FRUITVALE ISD ADMINISTRATION BLDG FRUITVALE, TEXAS 75127 WATER FLOOR PLAN




Issue/Revision Date & Description
IFB 7-01-2021


Job Number: 050-21003

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FLOOR DRAIN DETAIL SCALE: NO SCALE

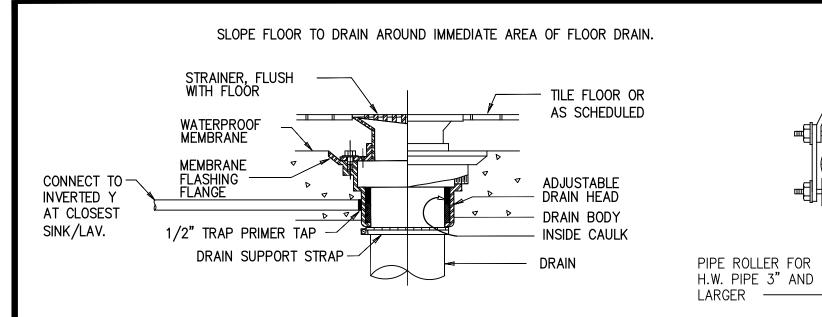

WALL CLEANOUT DETAIL

RELATED INSULATION

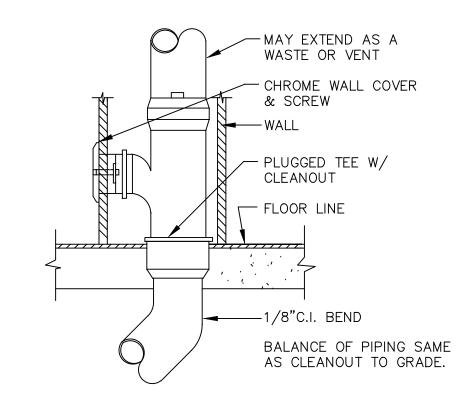-SUPPORTS LOCATED IN 6' SPANS $-\!-$

PEX-A PIPE SUPPORT DETAIL

—PEX FITTING

SCALE: NO SCALE

PEX PIPE

└─PEX—a PIPE SUPPORT

SCALE: NO SCALE

PIPING HANGERS AND SUPPORT DETAIL SCALE: NO SCALE

UNISTRUT CHANNEL

INSULATION

SHIELD FOR PIPE 3"

AND LARGER ----

DOUBLE NUTS OR

LOCK NUTS(TYP. FOR ALL SUPPORTS) FLAT WASHERS

HANGER ROD


- STRAP AT MID-SPAN

-PEX—a PIPE SUPPORT

-INSULATION (TYP.)

- STRUT CLAMP

PEX—a PIPE SUPPORT

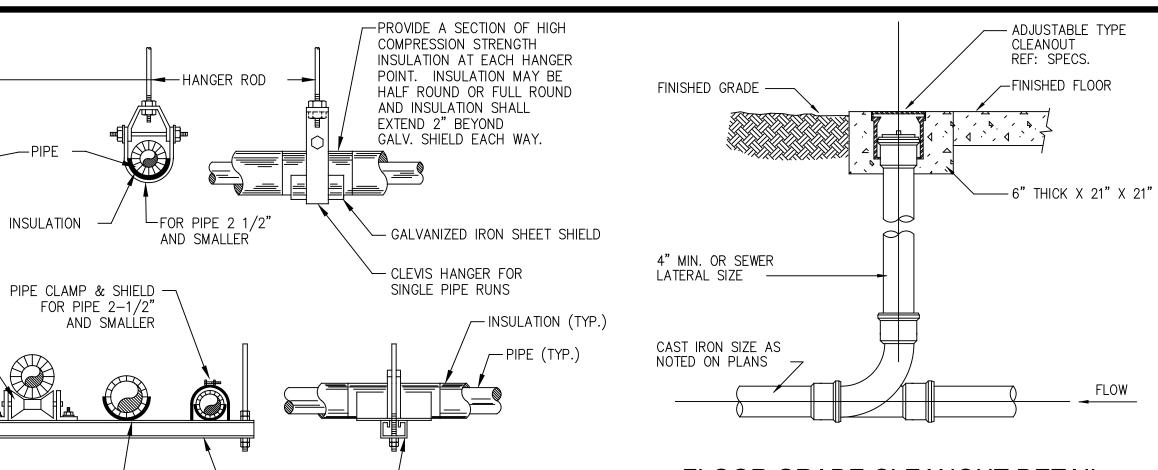

FLOOR GRADE CLEANOUT DETAIL SCALE: NO SCALE

GENERAL NOTES

- A. HOT AND COLD WATER PIPING SHALL BE PEX PIPING AND FITTINGS AS MANUFACTURED BY WATTS OR OWNER APPROVED EQUAL. HOT AND COLD WATER PIPING SHALL BE INSULATED ABOVE AND BELOW GRADE WITH 1/2" ARMAFLEX (OR EQUAL)
- CONTRACTOR SHALL FURNISH AND INSTALL SHUT-OFF VALVES AT ALL HOT AND COLD WATER CONNECTIONS.
- CONTRACTOR SHALL FURNISH AND INSTALL ALL NECESSARY FITTINGS & HARDWARE FOR CONNECTION OF NEW EQUIPMENT AND FIXTURES INCLUDING VACUUM BREAKERS, BACK FLOW PREVENTORS, ETC. AS REQUIRED BY CODE.
- WASTE AND VENT PIPING SHALL BE SCHD. 40 PVC. EXTERIOR ABOVE GRADE DW PIPING SHALL HAVE AN ALUMINUM JACKET.
- WASTE AND VENT PIPING MATERIALS, FITTINGS, ACCESSORIES AND THEIR INSTALLATION SHALL MEET ALL LOCAL CODE REQUIREMENTS.
- CONTRACTOR SHALL FURNISH AND INSTALL NECESSARY HANGER SUPPORTS, ACCESSORIES AND FITTINGS REQUIRED FOR THE PROPER INSTALLATION AND OPERATION OF THE PLUMBING SYSTEM AS REQUIRED BY CODE AND MANUFACTURER.
- G. CONTRACTOR SHALL COORDINATE NEW WORK WITH EXISTING UTILITIES AND OTHER TRADES.
- H. WATER SUPPLY, WASTE & VENT SYSTEMS SHALL BE PRESSURE TESTED AND INSPECTED BEFORE USE. SYSTEMS SHALL NOT BE CONCEALED PRIOR TO TESTING AND INSPECTING. PRESSURE TESTING REQUIREMENTS SHALL BE IN ACCORDANCE WITH LOCAL AND OR INTERNATIONAL CODE REQUIREMENTS. WATER SUPPLY SHALL BE DISINFECTED PRIOR TO PLACING IN
- PROVIDE CHROME-PLATED ESCUTCHEONS WITH SET SCREWS ON ALL PIPES PASSING THROUGH WALLS, FLOORS, OR CEILINGS OF FINISHED ROOMS.

	LEGEND
——————————————————————————————————————	FREEZE PROOF WALL FAUCET FLOOR DRAIN POINT OF CONNECTION FLOOR SINK MOP SINK LAVATORY URINAL WATER CLOSET ELECTRIC WATER COOLER GREASE INTERCEPTOR HAND SINK DISHWASHER ICE MACHINE ABOVE FINISHED FLOOR BELOW FINISHED FLOOR WATER METER GAS WATER HEATER FLOOR CLEANOUT WALL CLEANOUT WALL CLEANOUT TWO WAY CLEANOUT TWO WAY CLEANOUT VENT THRU ROOF CONDENSATE DRAIN OVER FLOW DRAIN WATER SUPPLY BOX SANITARY SEWER LINE GREASE WASTE LINE GREASE WASTE LINE VENT LINE GAS LINE FILTERED WATER LINE COLD WATER LINE HOT WATER LINE (140°F.) TEMPERED WATER LINE (110°F.) HOT WATER RETURN LINE BALANCING VALVE GATE VALVE

NOTE BY SYMBOL

FOR EQUIP. INFORMATION REFER TO PLUMBING

INFORMATION REFER TO NOTES BY SYMBOL EACH

FIXTURE SCHEDULE. NOTE BY SYMBOL

TIXTOIL DATA		CONNECTION DATA									
ITEM ID	EQUIP. & FIXTURES	MFG./ MODEL #	S 0 1	V E N	T R A	INDIRECT WASTE	V	VATE	R	GAS (CFH)	REMARKS
			L	T	Р		CW	HW	TW		
IEWH	INSTANTANEOUS ELECTRIC WATER HEATER	RHEEM/ RTEX 13	_	_	_	_	1/2"	1/2"	_	_	INSTANTANEOUS ELECTRIC WATER HEATER, .3 TO 4 GPM, 8KW, 208/240V. SET AT 120°F MAX.
A.P.	ACCESS PANEL	ELMDOR/ PW SERIES	_	-	_	_	1½"	_	_	_	10"x10" SQUARE STAINLESS STEEL ACCESS PANEL.
FC0	FLOOR CLEANOUT	JOSAM/57000	_	_	_	_	_	_	_	_	COATED CAST IRON FLOOR CLEANOUT
SK	KITCHEN SINK ADA/TAS	ELKAY/DART CANYON SS/ ELDSSF33279DBG	2"	1½"	2"	_	1/2"	1/2"	_	_	STAINLESS STEEL, 33"x27", 95%" DEEP, 1—HOLE SINGLE BOWL FARMHOUSE ADA WITH WORKSHELF. KOHLER CRUE SINGLE HANDLE SINK FAUCET; VIBRANT STAINLESS. ELKAY LK99 DRAIN.
S.A.	SHOCK ABSORBER	JOSAM/ 75000-S	_	_	_	_	_	_	_	_	PDI SIZE B
FD	FLOOR DRAIN	JOSAM/ 30003-7A	3"	2"	3"	_	_	_	_	_	PROVIDE TRAP PRIMER TAP FED FROM INVERTED Y ON CLOSEST SINK/LAV.
FPWF	FREEZE PROOF WALL FAUCET	WOODFORD MODEL 30	_	-	_	_	3/4"	-	_	_	
EWC	ELEC. WATER COOLER	ELKAY/ LZWS-EDFP217K	2"	1½"	2"	_	1/2"	_	_	_	BI-LEVEL ADA COMPLIANT WATER COOLER WITH BOTTLE FILLING STATION.
WC	HANDICAPPED WATER CLOSET ADA/TAS	AMERICAN STANDARD/ MADERA 3461.660	4"	2"	_	_	1"	_	_	-	HANDICAPPED VITREOUS CHINA FLUSH VALVE, FLOOR MTD. WATER CLOSET WITH ELONGATED SIPHON JET BOWL 1.6 GPF WITH SEAT MIN 17" AND MAX 19" AFF. FURNISH COMPLETE WITH A.S. 5901.100 OPEN FRONT TOILET SEAT, SELECTRONIC FLUSH VALVE.
WCO	WALL CLEANOUT	JOSAM/58600	_	-	_	_	_	_	_	_	
LAV	HANDICAPPED LAVATORY ADA/TAS	AMERICAN STANDARD/ AQUALYN 0476.028	2"	1 <u>1</u> "	147	_	1/2"	1/2"	_	_	VITREOUS CHINA COUNTERTOP SINK. AMERICAN STANDARD INNSBROOK SELECTRONIC FAUCET BATTERY POWERED (6053.205 WITH OPTIONAL MIXING VALVE 605XTMV1070). OFFSET TAILPIECE MCGUIRE CHROME SUPPLIES, LOOSE KEY ANGLE STOPS, 1½"X1½" C.P. 17 GAUGE ADJUSTABLE P—TRAP WITH CLEANOUT AND CHROME SET SCREW ESCUTCHEONS THROUGH WALL, "TRUBRO LAV—GAURD" INSULATION KIT NO. 101. INSTALLATION SHALL COMPLY WITH ADA REQUIREMENTS
MS	MOP SINK	FIAT/MSB2424	3"	2"	3"	-	3/4"	3⁄4"	_	-	MOLDED-STONE MOP SERVICE BASIN, WHITE WITH STAINLESS STEEL STRAINER, DRAIN BODY AND LINT BASKET. WITH FIAT 830-AA COMBINATION FITTING WITH VACUUM BREAKER, ¾" HOSE THREAD ON SPOUT, PAIL HOOK, WITH LEVER HANDLES, INTEGRAL STOPS, AND WALL BRACE.
WSB	WATER SUPPLY BOX	OATEY/ 37899	_	_	_	_	1/2"	_	_	_	TAILPIECE F1807 PEX (BRASS), %" OD COMPRESSION OUTLET.
	'			1	<u> </u>		1			1	

PLUMBING FIXTURE SCHEDULE

CONNECTION DATA

FIXTURE DATA

- ALL PLUMBING FIXTURES SHALL MEET LOW WATER CONSUMPTION REQUIREMENTS.
- PLUMBING CONTRACTOR SHALL PROVIDE SHUT-OFF VALVES AND STOPS AT ALL FIXTURES. PLUMBING CONTRACTOR SHALL PROVIDE ALL ADA LAVATORIES WITH OFFSET DRAIN CONNECTIONS TO ENSURE ADA/TAS
- PLUMBING CONTRACTOR SHALL PROVIDE ALL ADA SINKS WITH OFF-CENTERED DRAIN OPENINGS TO ENSURE ADA/TAS COMPLIANCE. PLUMBING CONTRACTOR SHALL INSTALL FLUSH CONTROL LEVERS/HANDLES ON WIDE SIDE FOR ALL WATER CLOSETS TO ENSURE
- PLUMBING CONTRACTOR SHALL INSTALL TRUEBRO (SUPPLY AND DRAIN) PIPE COVERS ON ALL SINKS AND LAVATORIES (IF
- REMOVABLE PROTECTIVE SKIRT/PANEL NOT PROVIDED BY ARCHITECT) TO ENSURE ADA/TAS COMPLIANCE.
- PLUMBING CONTRACTOR SHALL INSTALL ALL PLUMBING FIXTURES ACCORDING TO AND/OR IN COMPLIANCE WITH ADA/TAS REQUIREMENTS AND GUIDELINES. PLUMBING CONTRACTOR SHALL COORDINATE ROUGH-IN DIMENSIONS AND MOUNTING HEIGHTS WITH ARCHITECTURAL DRAWINGS BEFORE PURCHASING ANY FIXTURES AND ACCESSORIES AND BEFORE PROCEEDING WITH CONSTRUCTION.
- COORDINATE AND VERIFY COLOR SELECTIONS AND FINISH OPTIONS WITH OWNER BEFORE PURCHASING ANY FIXTURES, TRIM AND
- ACCESSORIES. OTHER MANUFACTURERS OF PLUMBING PRODUCTS ARE ACCEPTABLE, MANUFACTURERS SHOWN ARE USED TO SET STANDARD OF

i3"VTR CEILING LINE **~—**2"CW**──**1¼"CW**─**\$ **₹**—1¼"CW−

PLUMBING RISER

SCALE: NTS

Job Number: 050-21003 Sheet Number:

ALE ION AS 75